

DATE: 03/28/2025 MCG JOB #: 24.179.05 DATE

REVISIONS

©MCG ARCHITECTURE 2025 ALL RIGHTS RESERVED NOTE: This information is conceptual in nature and is subject to adjustments pending further verification and Client, Tenant, and Governmental Agency approvals. No warranties or guaranties of any kind are given or implied by the Architect.



CENTRAL AVE & SCHAEFER AVE CHINO, CA 91710



PROJECT DIRECTORY

APPLICANT:

STARBUCKS 2401 UTAH AVENUE SOUTH SEATTLE, WA 98134

Contact: JORGE CALDERON

Tel. No.: (714) 477-2816

MCG ARCHITECTURE 1501 WEST FOUNTAINHEAD PARKWAY, SUITE 321 TEMPE, AZ 85282 Tel. No.: (602) 813-0778

E-Mail: JCALDERON@MCGARCHITECTURE.COM

SITE DATA

A.P.N. NO.: 1020-571-12-0-000 EXISTING ZONING: CENTRAL AVENUE SPECIFIC PLAN (CS)

GENERAL PLAN LAND USE DESIGNATION: GENERAL COMMERCIAL **EXISTING DEVELOPMENT:** VACANT LOT

SITE AREA:

GROSS-0.86 ACRES (37,461.6 S.F.) NET (-MINUS RIGHT-OF-WAY 0.84 ACRES (36,721 S.F.) DEDICATIONS)

LOT COVERAGE 6.2% PROVIDED (MAX ALLOWABLE 45%)

LANDSCAPE COVERAGE: 22.9% PROVIDED (MINIMUM. 10%) .06 PROVIDED FLOOR AREA RATIO:

(ALLOWABLE 0.6) IMPERVIOUS AREA RATIO: .76 PROVIDED PROPOSED USE: RESTAURANT (DRIVE-THRU)

CONSTRUCTION TYPE: OCCUPANCY:

BUILDING AREA: 2,262 SF PARKING REQUIRED: 1 SPACE FOR EACH 100 S.F. PUBLIC SEATING AREA. MINIMUM

OF 10 SPACES SHALL BE PROVIDED. (476 SF INDOOR, 200 SF OUTDOOR). A QUEING LANE SUFFICIENT IN LENGTH TO ACCOMMODATE 5 VEHICLES AT THE POINT OF FOOD ORDERING SHALL BE PROVIDED. PARKING PROVIDED: 22 SPACES

ACCESSIBLE SPACES REQUIRED: ACCESSIBLE SPACES PROVIDED: 3 SPACE BICYCLE PARKING REQUIRED: 1 SPACE BICYCLE PARKING PROVIDED: 2 SPACES

LANDSCAPED AREA

- — → ADA ACCESS PATH

PROJECT SCOPE OF WORK: PROPOSED NEW DEVELOPMENT OF A 2,262 SF SINGLE STORY

ENCLOSURE.

LEGAL DESCRIPTION:

PARCEL 6 OF PARCEL MAP NO. 14905, IN THE CITY OF CHINO, COUNTY OF SAN BERNADINO, STATE OF CALIFORNIA, AS SHOWN ON A MAP RECORDED IN BOOK 190, PAGES 40 THROUGH 43, INCLUSICE OF PARCEL MAPS, IN THE OFFICE OF THE COUNTY RECORDER OF SAID COUNTY.

KETNOTES

A/C PAVED SURFACE CONCRETE DRIVE-THRU LANE

ACCESSIBLE PARKING STALL AND RAMP

ACCESSIBLE SIGNAGE WAYFINDING GRAPHIC

6. DRIVE-THOUGH LANE CLEARANCE BAR DIRECTIONAL SIGNAGE, LEFT TURN ONLY

8. PRE-ORDER MENU BOARD 9. DIGITAL MENU / ORDER BOARD


10. 5 PANEL MENU BOARD

11. PAVEMENT MARKING 13. CONCRETE SIDEWALK

14. BICYCLE PARKING

15. NEW TRANSFORMER, FINAL LOCATION TO BE COORDINATED WITH UTILITY COMPANY 16. EXISTING TREE PROTECT IN PLACE

VICINITY MAP

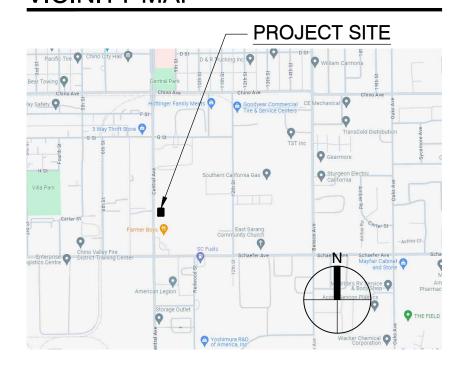



SHEET TITLE:


SITE PLAN

SHEET NUMBER:

SP-1

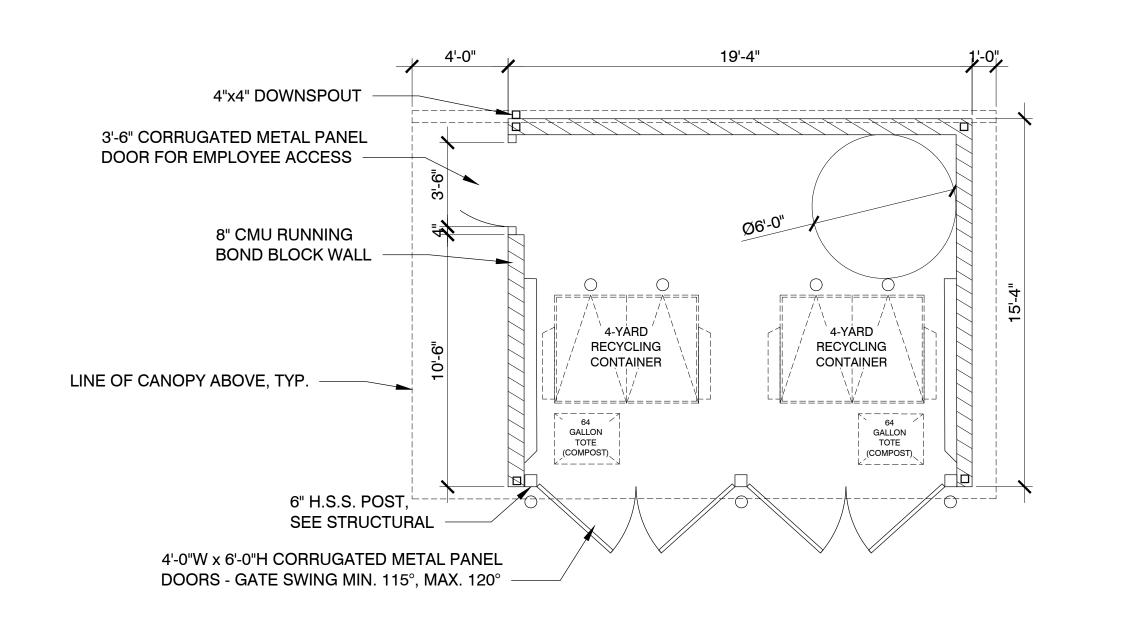


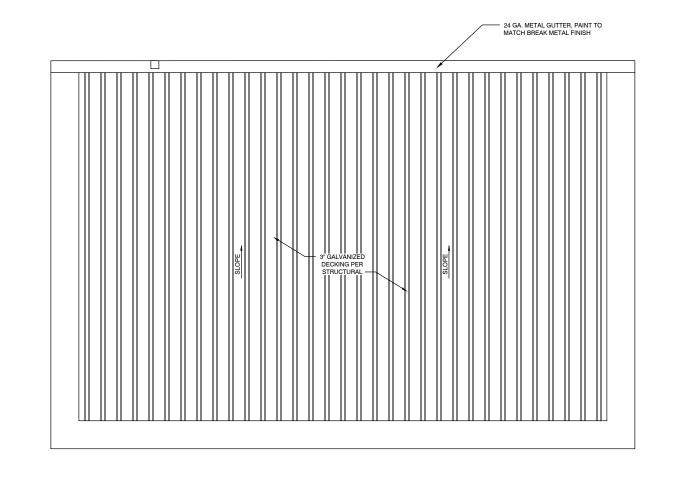

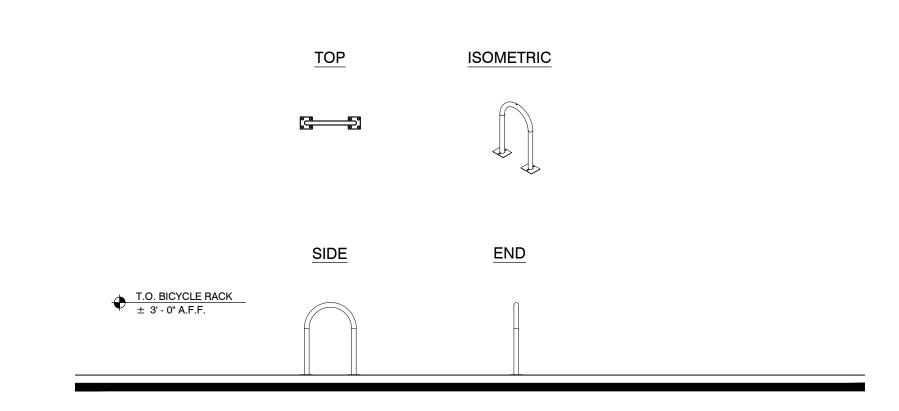


TRASH ENCLOSURE
PLAN

TRASH ENCLOSURE ROOF PLAN

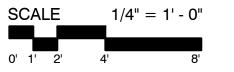

BICYCLE RACK

DETAILS

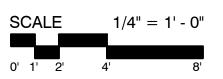

KEYNOTES

(1) BOLLARD. PAINT YELLOW.

PROJECT DIRECTORY

ARCHITECT: MCG ARCHITECTURE

MATERIALS & COLORS

ANGELUS

6" GALVANIZED STEEL SQ. TUBE

DECORATIVE METAL LATTICE

FINISH SPLIT FACE

STARBUCKS

SEATTLE, WA 98134 Tel. No.: (714) 477-2816

TEMPE, AZ 85282
Tel. No.: (602) 813-0778
Contact: JORGE CALDERON

PROPOSED NEW DEVELOPMENT OF A 2,262 SF SINGLE STORY DRIVE-THRU COFFEE SHOP RESTAURANT AND NEW TRASH

CORRUGATED METAL DOORS
COLOR TO MATCH RAL7016 "ANTHRACITE GREY"

2401 UTAH AVENUE SOUTH

1501 WEST FOUNTAINHEAD PARKWAY, SUITE 321

E-Mail: JCALDERON@MCGARCHITECTURE.COM

APPLICANT:


PROJECT SCOPE OF WORK:

FRONT SIDE

15 CALION
9 (7 A A A S)
10 S E
10 S CALION
10 S E
10 S CALION
10 S

TRASH ENCLOSURE

ELEVATIONS

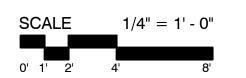


DRIVE-THRU COFFEE SHOP CENTRAL AVE & SCHAEFER AVE

CENTRAL AVE & SCHAEFER AVE CHINO, CA 91710



VICINITY MAP

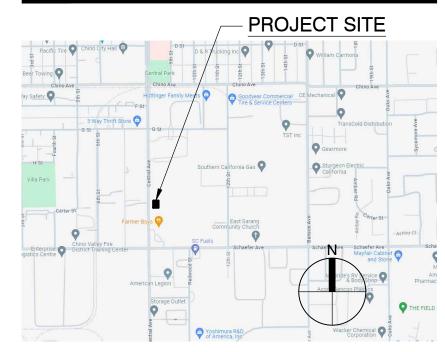

SHEET TITLE:

SITE DETAILS

SHEET NUMBER:


D-1


DATE: 10/30/2024
MCG JOB #: 24.179.05

DATE REVISIONS

©MCG ARCHITECTURE 2024 ALL RIGHTS RESERVED NOTE: This information is conceptual in nature and is subject to adjustments pending further verification and Client, Tenant, and Governmental Agency approvals. No warranties or guaranties of

any kind are given or implied by the Architect.

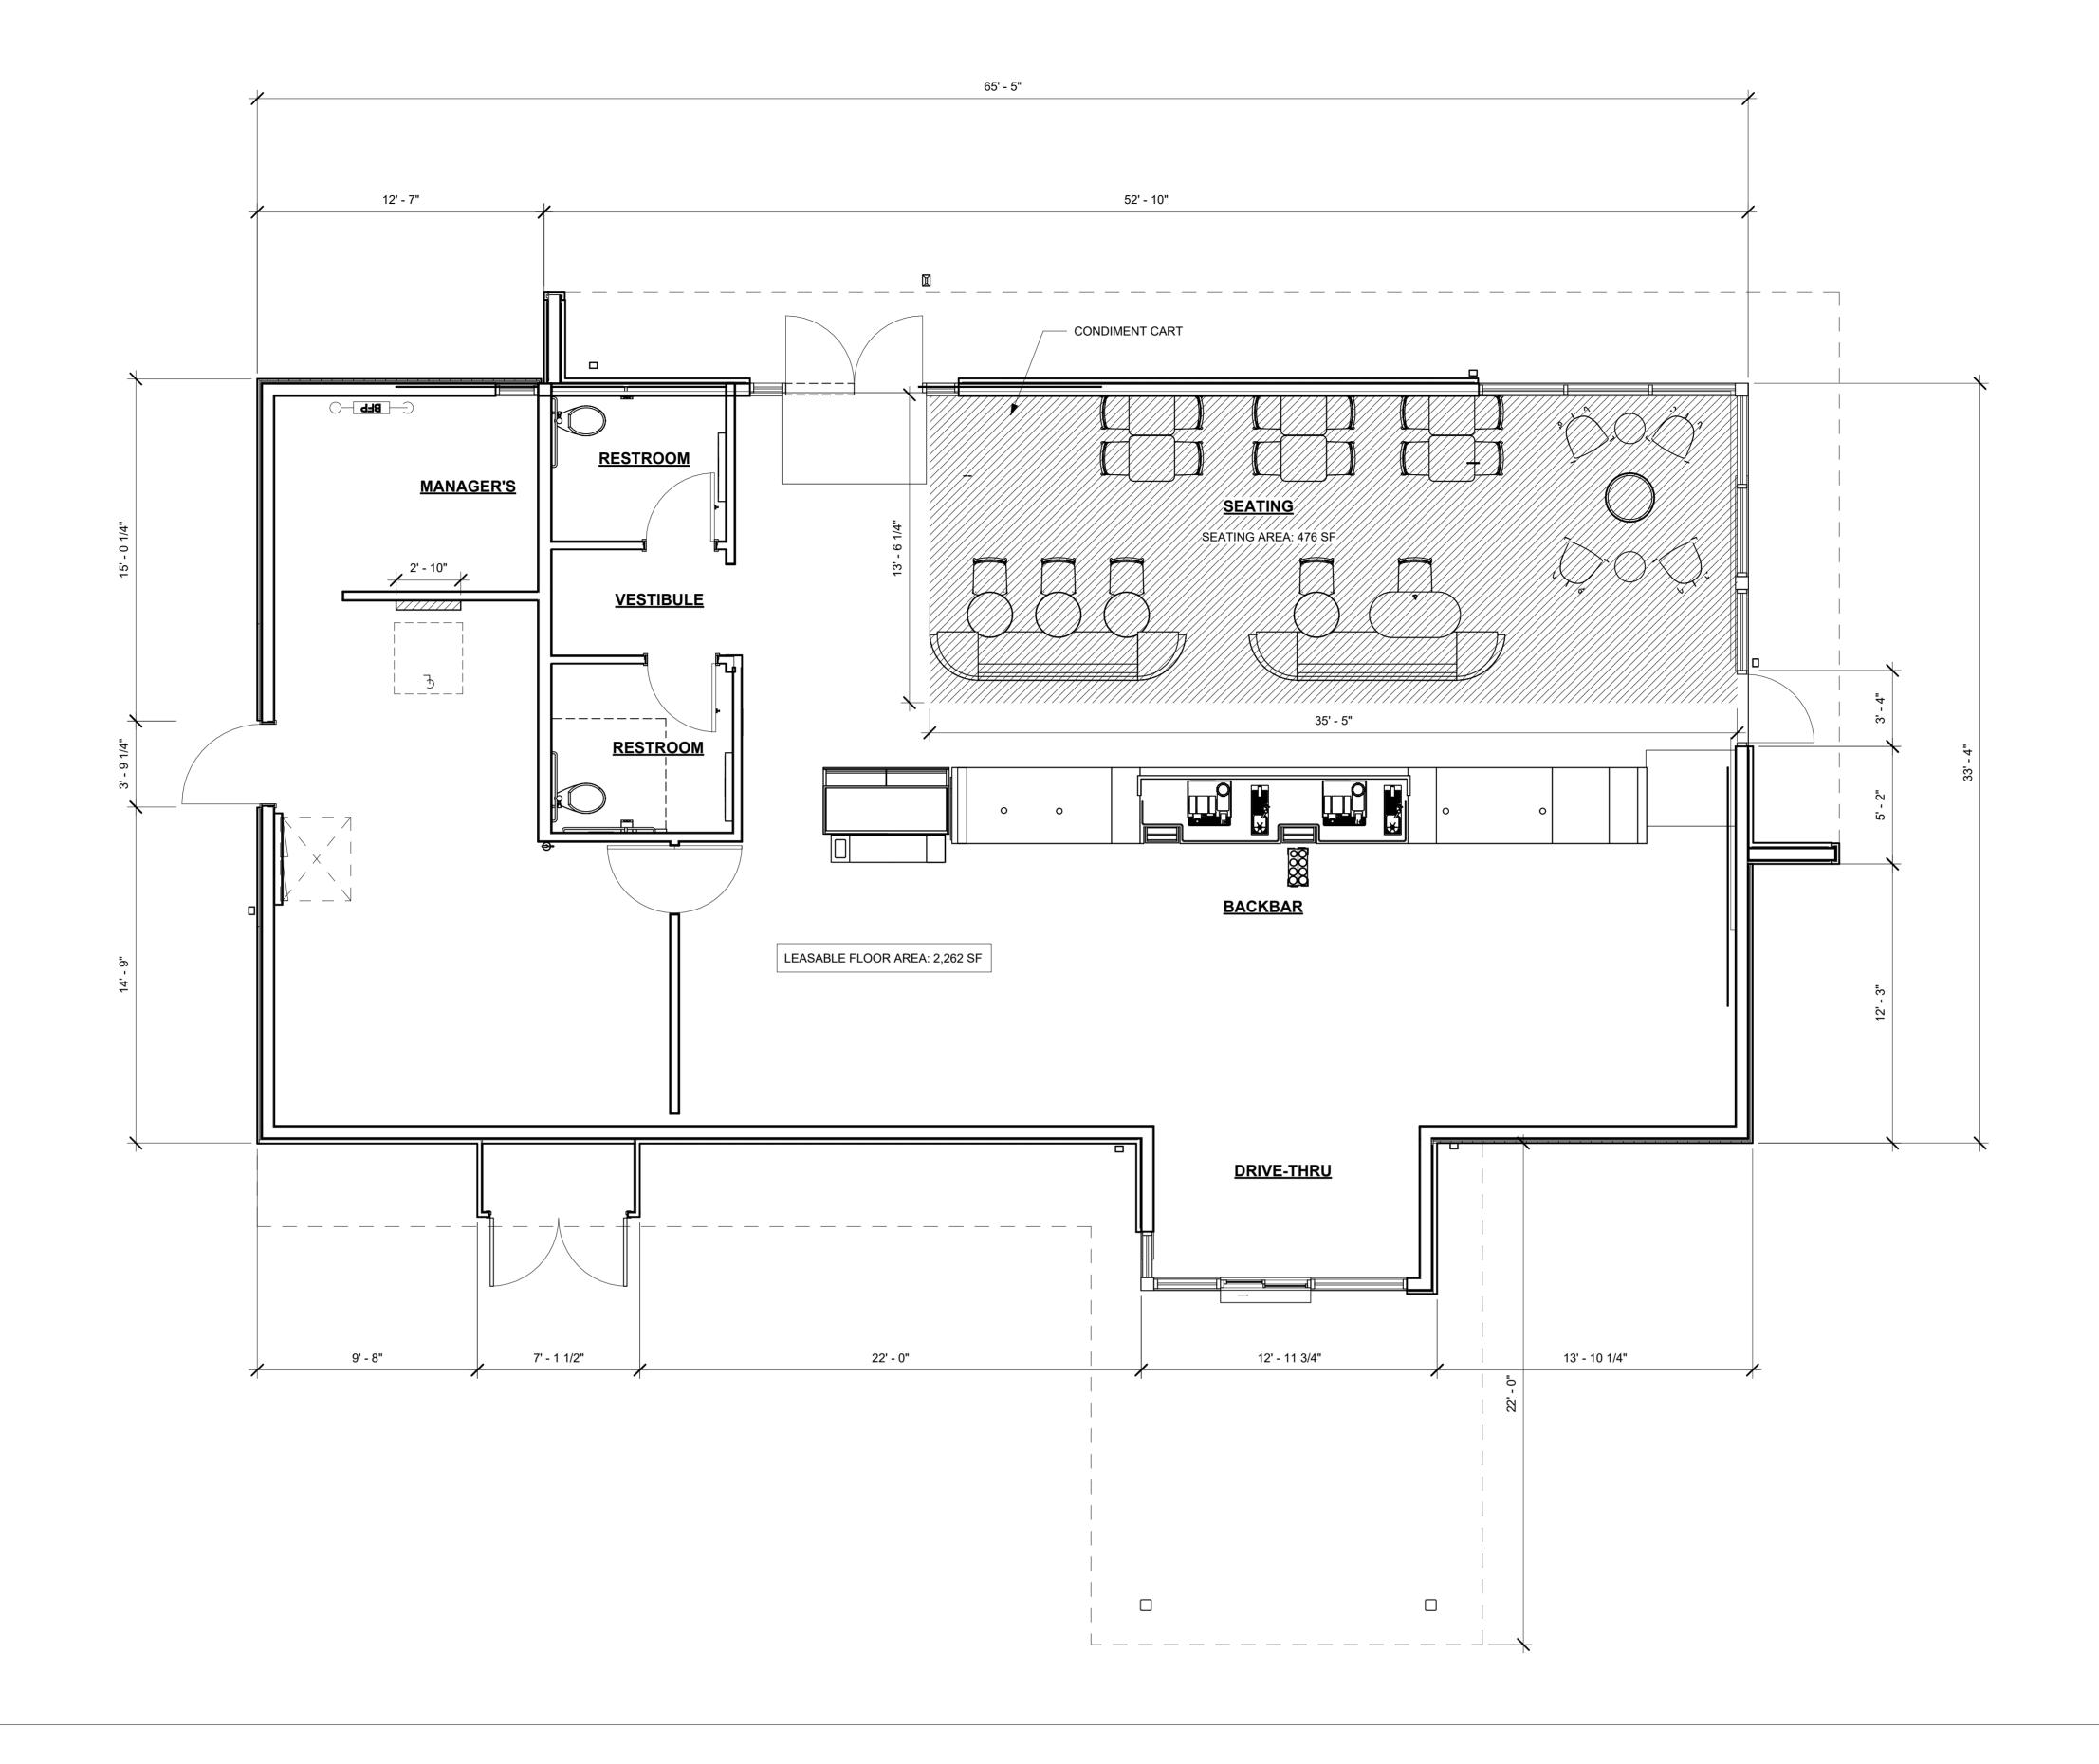

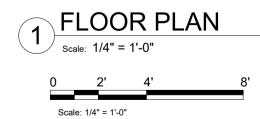

DATE: 10/30/2024 MCG JOB #: 24.179.05

DATE:

REVISIONS

DRIVE-THRU COFFEE SHOP CENTRAL AVE & SCHAEFER AVE

CENTRAL AVE & SCHAFER AVE CHINO, CA 91710



SHEET TITLE:

SCHEMATIC FLOOR

PLAN

SHEET NUMBER:

SD-1

CONCEPT PLANT SCHEDULE



TOTAL SITE AREA:

0.86 ACRES @ 20 TREES PER ACRE (17) TREES REQUIRED

(23) TREES PROVIDED.(8) TREES 36" BOX 34%

(8) TREES 24" BOX 34%

(7) TREES 15 GAL. 30%


PRELIMINARY WATER USE CALCULATIONS:

M.A.W.A. = 54.6) (0.62) [(0.45 x 9,131)] = 139,096 gal / yr.

E.T.W.U. = $(54.6) (0.62) \left[(0.3 \times 9,131) \right]$

114,487 gal / yr.

"I HAVE COMPLIED WITH THE CRITERIA OF THE CITY OF CHINO WATER EFFICIENT LANDSCAPE ORDINANCE (CHINO MUNICIPAL CODE 2015-008) AND APPLIED THEM FOR THE EFFICIENT USE OF WATER IN THE LANDSCAPE DESIGN PLAN;"

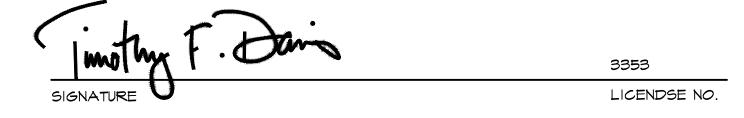

03/28/2025

TREES WITHIN 6 FEET OF HARDSCAPE SHALL BE INSTALLED WITH APPROVED ROOT CONTROL BARRIER (16 FEET LENGTH TOTAL MIN. EACH TREE)

ALL GROUND-MOUNTED ELECTRICAL/MECHANICAL EQUIPMENT SHALL BE EFFECTIVELY SCREENED WITH LANDSCAPING

IRRIGATION SYSTEM DESIGN STATEMENT:

A PERMANENT AUTOMATIC SUB-SURFACE IRRIGATION SYSTEM SHALL BE DESIGNED AND INSTALLED TO IRRIGATE ALL PLANTING AREAS. THE IRRIGATION CONTROLLER(S) SHALL BE EQUIPPED FROM THE MANUFACTURER WITH WEATHER/EVAPOTRANSPIRATION (ET) SENSING CAPABILITIES TO AUTOMATICALLY ADJUST WATERING SCHEDULES AND AMOUNTS. THE DESIGN OF THE IRRIGATION SYSTEM SHALL EMPHASIZE WATER CONSERVATION AND PROVIDE EFFICIENT AND UNIFORM DISTRIBUTION OF IRRIGATION WATER. DRIP AND/OR BUBBLER IRRIGATION, OR OTHER LOW-VOLUME, LOW-PRESSURE MICRO-IRRIGATION- SYSTEM PER CITY OF CHINO ZONING CODE 20.15 AND SHALL BE INSTALLED IN PLANTER AREAS TO PROVIDE WATER DIRECTLY TO THE ROOT ZONE OF PLANTS.



Conceptual Landscape Plan

DRIVE-THRU COFFEE SHOP CENTRAL AVE & SCHAEFER AVE

CENTRAL AVE & SCHAEFER AVE CHINO, CA 91710



Wilson Davis Associates
Landscape Architecture
2825 Litchfield Dr.
Riverside, CA 92503
Ph.(951) 353-2436




MCG JOB #: 24.179.01

DATE REVISIONS

DATE:

©MCG ARCHITECTURE 2024 ALL RIGHTS RESERVED

NOTE: This information is conceptual in nature and is subject to adjustments pending further verification and Client, Tenant, and Governmental Agency approvals. No warranties or guaranties of any kind are given or implied by the Architect.

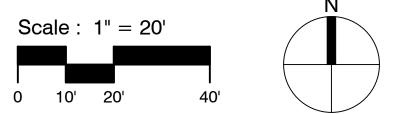

m c g a r c h i t e c t u r e . c o m

SAN FRANCISCO

SAN FRANCISCO

CONCEPTUAL LANDSCAPE PLAN

SHEET NUMBER:

L1.(



ELEAGNUS PUNGENS THORNY ELEAGNUS



LANTANA 'NEW GOLD' NEW GOLD LANTANA



MUHLENBERGIA CAPILLARIS 'PINK CLOUD PINK CLOUD MUHLY GRASS



ALOE STRIATA CORAL ALOE



WESTRENGIA FRUITICOSA COAST ROSEMARY



CISTUS PURPUREUS -PURPLE ROCKROSE



ROSMARINUS OFFICIANALIS 'PROSTRATUS' DWARF ROSEMARY



MYOPORUM PARVIFOLIUM TRAILING MYOPRUM



OENOTHERA SPECIOSA MEXICAN EVENING PRIMROSE



PLATANUS ACERIFOLIA 'BLOODGOOD' LONDON PLANE TREE (MATCHES EXISTING PARKING LOT ISLAND TREES)



LAGERSTROEMIA INDICA FAUERI 'NATCHEZ' WHITE CREPE MYRTLE




CERCIDIUM X 'DESERT MUSEUM' 'DESERT MUSEUM' PALO VERDE


DATE: 11/08/2024 24.179.01 MCG JOB #:

REVISIONS DATE

©MCG ARCHITECTURE 2024 ALL RIGHTS RESERVED NOTE: This information is conceptual in nature and is subject to adjustments pending further verification and Client, Tenant, and Governmental Agency approvals. No warranties or guaranties of any kind are given or implied by the Architect.



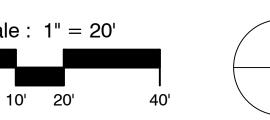

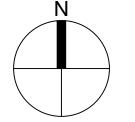

DRIVE-THRU COFFEE SHOP CENTRAL AVE & SCHAEFER AVE

CENTRAL AVE & SCHAEFER AVE CHINO, CA 91710







SHEET TITLE: CONCEPTUAL LANDSCAPE PLAN



CENTRAL AVE & SCHAEFER AVE CHINO, CA 91710

MATERIALS LEGEND:

MATERIALS:

- 1. HARDIE LAP SIDING TO MATCH SW6102 PORTABELLO
- 2. HARDIE LAP SIDING TO MATCH SW7020 BLACK FOX
- 3. HARDIE BOARD & BAT SIDING TO MATCH SW7020 BLACK FOX
- 4. METAL CANOPY TO MATCH SW7020 BLACK FOX
- 5. ALUMINUM STOREFRONT
- 6. BUILDING SIGNAGE
- 7. OPAQUE WINDOW FILM COLOR TO MATCH SW7020 BLACK FOX

COLORS:



A. FIBER CEMENT PLANK
MANUFACTURER: JAMES HARDIE
PRODUCT: HARDIE PLANK
PRIMED FOR PAINT
COLOR: MATCH TO SW6102 PORTABELLO



B. FIBER CEMENT PLANK
MANUFACTURER: JAMES HARDIE
PRODUCT: HARDIE PLANK
PRIMED FOR PAINT
COLOR: MATCH TO SW7020 BLACK FOX



C. BOARD & BAT SIDING

MANUFACTURER: JAMES HARDIE

PRODUCT: SIERRA 8 HARDIE PANEL

PRIMED FOR PAINT

COLOR: MATCH TO SW7020 BLACK FOX



D. STOREFRONT

MANUFACTURER: KAWNEER

PRODUCT: TRIFAB VERSAGLAZE 451/451T

COLOR: #29 BLACK ANODIZED




E. PAINT TO MATCH
COLOR: MATCH SW7020 BLACK FOX

SHEET TITLE

EXTERIOR ELEVATIONS

SHEET NUMBER:

EL-1

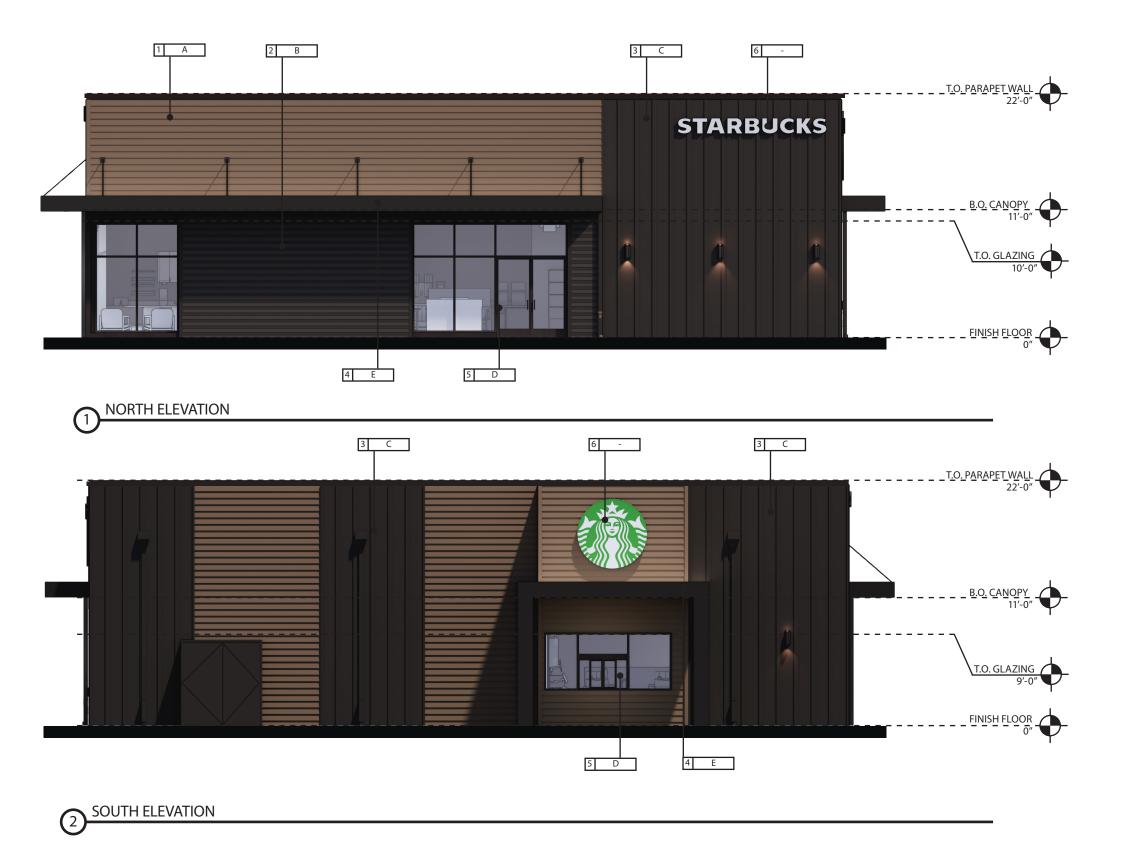

CENTRAL AVE & SCHAEFER AVE CHINO, CA 91710

MATERIALS LEGEND:


MATERIALS:

- 1. HARDIE LAP SIDING TO MATCH SW6102 PORTABELLO
- 2. HARDIE LAP SIDING TO MATCH SW7020 BLACK FOX
- 3. HARDIE BOARD & BAT SIDING TO MATCH SW7020 BLACK FOX
- 4. METAL CANOPY TO MATCH SW7020 BLACK FOX
- 5. ALUMINUM STOREFRONT
- 6. BUILDING SIGNAGE
- 7. OPAQUE WINDOW FILM COLOR TO MATCH SW6102 PORTABELLO

COLORS:



A. FIBER CEMENT PLANK
MANUFACTURER: JAMES HARDIE
PRODUCT: HARDIE PLANK
PRIMED FOR PAINT
COLOR: MATCH TO SW6102 PORTABELLO

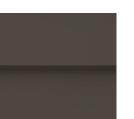

B. FIBER CEMENT PLANK
MANUFACTURER: JAMES HARDIE
PRODUCT: HARDIE PLANK
PRIMED FOR PAINT
COLOR: MATCH TO SW7020 BLACK FOX



C. BOARD & BAT SIDING
MANUFACTURER: JAMES HARDIE
PRODUCT: SIERRA 8 HARDIE PANEL
PRIMED FOR PAINT
COLOR: MATCH TO SW7020 BLACK FOX



D. STOREFRONT
MANUFACTURER: KAWNEER
PRODUCT: TRIFAB VERSAGLAZE 451/451T
COLOR: #29 BLACK ANODIZED




E. PAINT TO MATCH
COLOR: MATCH SW7020 BLACK FOX


SHEET TITLE

EXTERIOR ELEVATIONS

SHEET NUMBER:

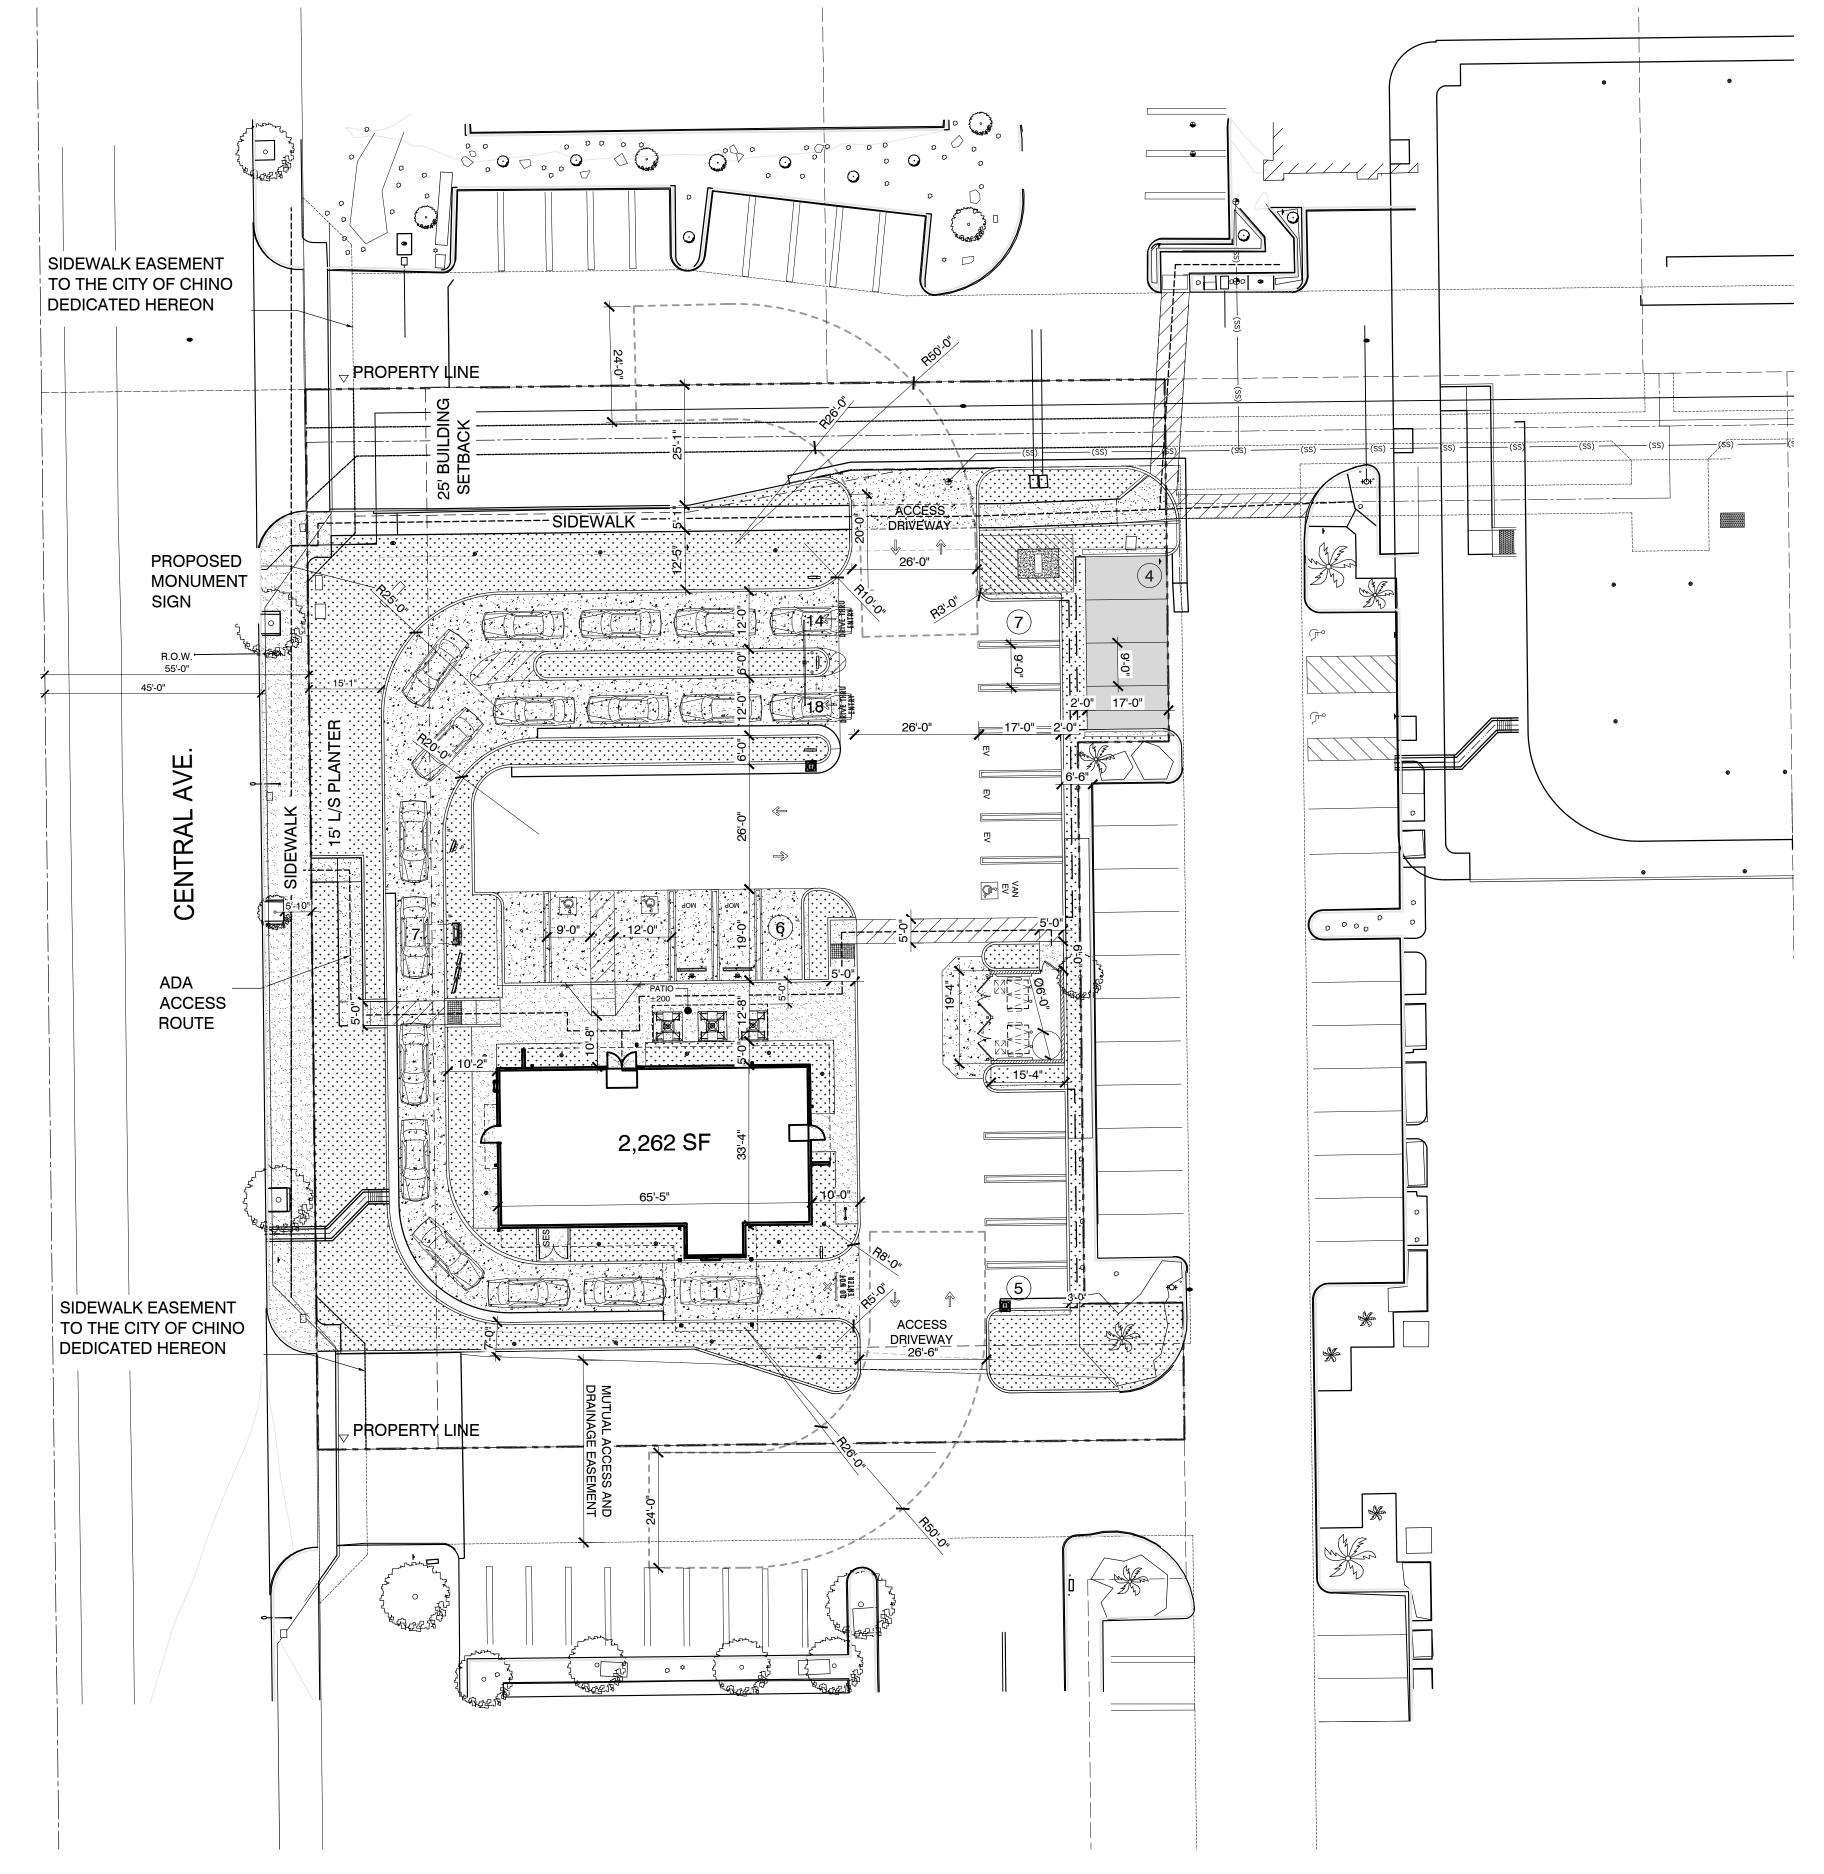

Scale: 1" = 20'

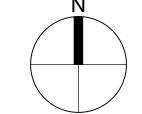

CENTRAL AVE & SCHAEFER AVE CHINO, CA 91710

m c g a r c h i t e c t u r e c c o m SAN FRANCISCO SAN FRANCISCO

PROJECT DIRECTORY

APPLICANT:

STARBUCKS 2401 UTAH AVENUE SOUTH SEATTLE, WA 98134

Tel. No.: (714) 477-2816

MCG ARCHITECTURE
1501 WEST FOUNTAINHEAD PARKWAY, SUITE 321
TEMPE, AZ 85282

Tel. No.: (602) 813-0778
Contact: JORGE CALDERON
E-Mail: JCALDERON@MCGARCHITECTURE.COM

SITE DATA

A.P.N. NO.: 1020-571-12-0-000 EXISTING ZONING: CENTRAL AVENUE SPECIFIC PLAN (CS)

GENERAL PLAN LAND
USE DESIGNATION:

EXISTING DEVELOPMENT:

VACANT LOT

SITE AREA:

(ALLOWABLE 0.6)

GROSSNET (-MINUS RIGHT-OF-WAY
DEDICATIONS)

0.86 ACRES (37,461.6 S.F.)
0.84 ACRES (36,721 S.F.)

LOT COVERAGE 6.2% PROVIDED (MAX ALLOWABLE 45%)

LANDSCAPE COVERAGE: 22.9% PROVIDED

(MINIMUM. 10%)

FLOOR AREA RATIO: .06 PROVIDED

IMPERVIOUS AREA RATIO: .76 PROVIDED
PROPOSED USE: RESTAURANT (DRIVE-THRU)

CONSTRUCTION TYPE: V-B

OCCUPANCY: B

BUILDING AREA: 2,262 SF

PARKING REQUIRED: 10 SPACES
1 SPACE FOR EACH 100 S.F. PUBLIC SEATING AREA. MINIMUM
OF 10 SPACES SHALL BE PROVIDED. (476 SF INDOOR, 200 SF
OUTDOOR). A QUEING LANE SUFFICIENT IN LENGTH TO
ACCOMMODATE 5 VEHICLES AT THE POINT OF FOOD
ORDERING SHALL BE PROVIDED.

PARKING PROVIDED: 22 SPACES

ACCESSIBLE SPACES REQUIRED: 1 SPACE
ACCESSIBLE SPACES PROVIDED: 3 SPACE

BICYCLE PARKING REQUIRED: 1 SPACE

2 SPACES

LANDSCAPED AREA

---> ADA ACCESS PATH

BICYCLE PARKING PROVIDED:

PROJECT SCOPE OF WORK:
PROPOSED NEW DEVELOPMENT OF A 2,262 SF SINGLE STORY
DRIVE-THRU COFFEE SHOP RESTAURANT AND NEW TRASH

LEGAL DESCRIPTION:

ENCLOSURE.

PARCEL 6 OF PARCEL MAP NO. 14905, IN THE CITY OF CHINO, COUNTY OF SAN BERNADINO, STATE OF CALIFORNIA, AS SHOWN ON A MAP RECORDED IN BOOK 190, PAGES 40 THROUGH 43, INCLUSICE OF PARCEL MAPS, IN THE OFFICE OF THE COUNTY RECORDER OF SAID COUNTY.

VICINITY MAP



PEDESTRIAN
ACCESS PLAN

EET NUMBER:

PA-1

©MCG ARCHITECTURE 2025 ALL RIGHTS RESERVED

NOTE: This information is conceptual in nature and is subject to adjustments pending further verification and Client, Tenant, and Governmental Agency approvals. No warranties or guaranties of any kind are given or implied by the Architect.

03/28/2025


24.179.05

REVISIONS

DATE:

MCG JOB #:

DATE

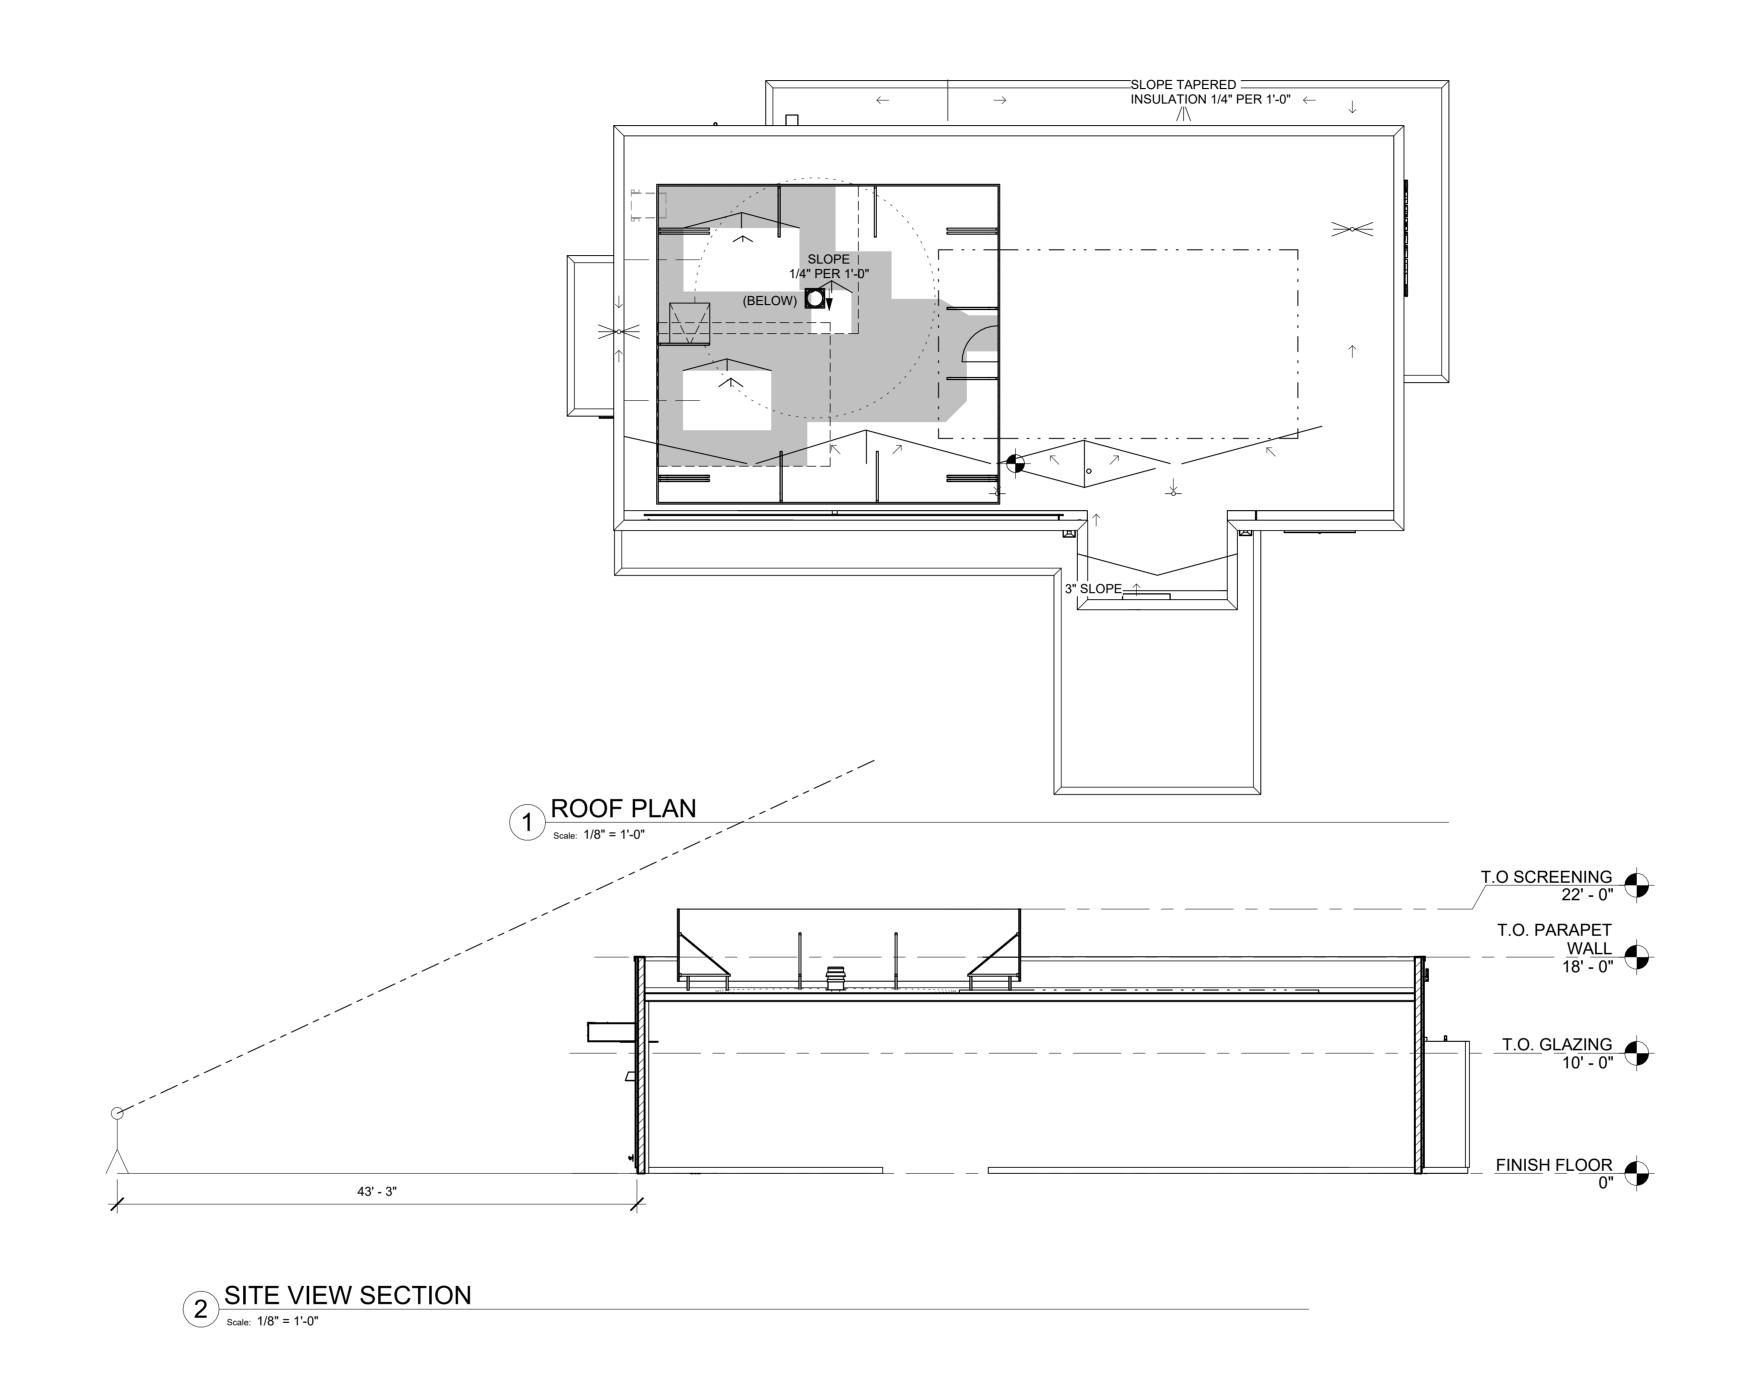

DATE: 10/30/2024 MCG JOB #: 24.179.05

DATE: REVISIONS

© MCG ARCHITECTURE 2024 ALL RIGHTS RESERVED NOTE: This information is conceptual in nature and is subject to adjustments pending further verification and Client, Tenant, and Governmental Agency approvals. No warranties or guaranties of any kind are given or implied by the Architect.

CENTRAL AVE & SCHAFER AVE CHINO, CA 91710




SHEET TITLE:


LINE OF SIGHT VIEW

SHEET NUMBER:

SEC-1

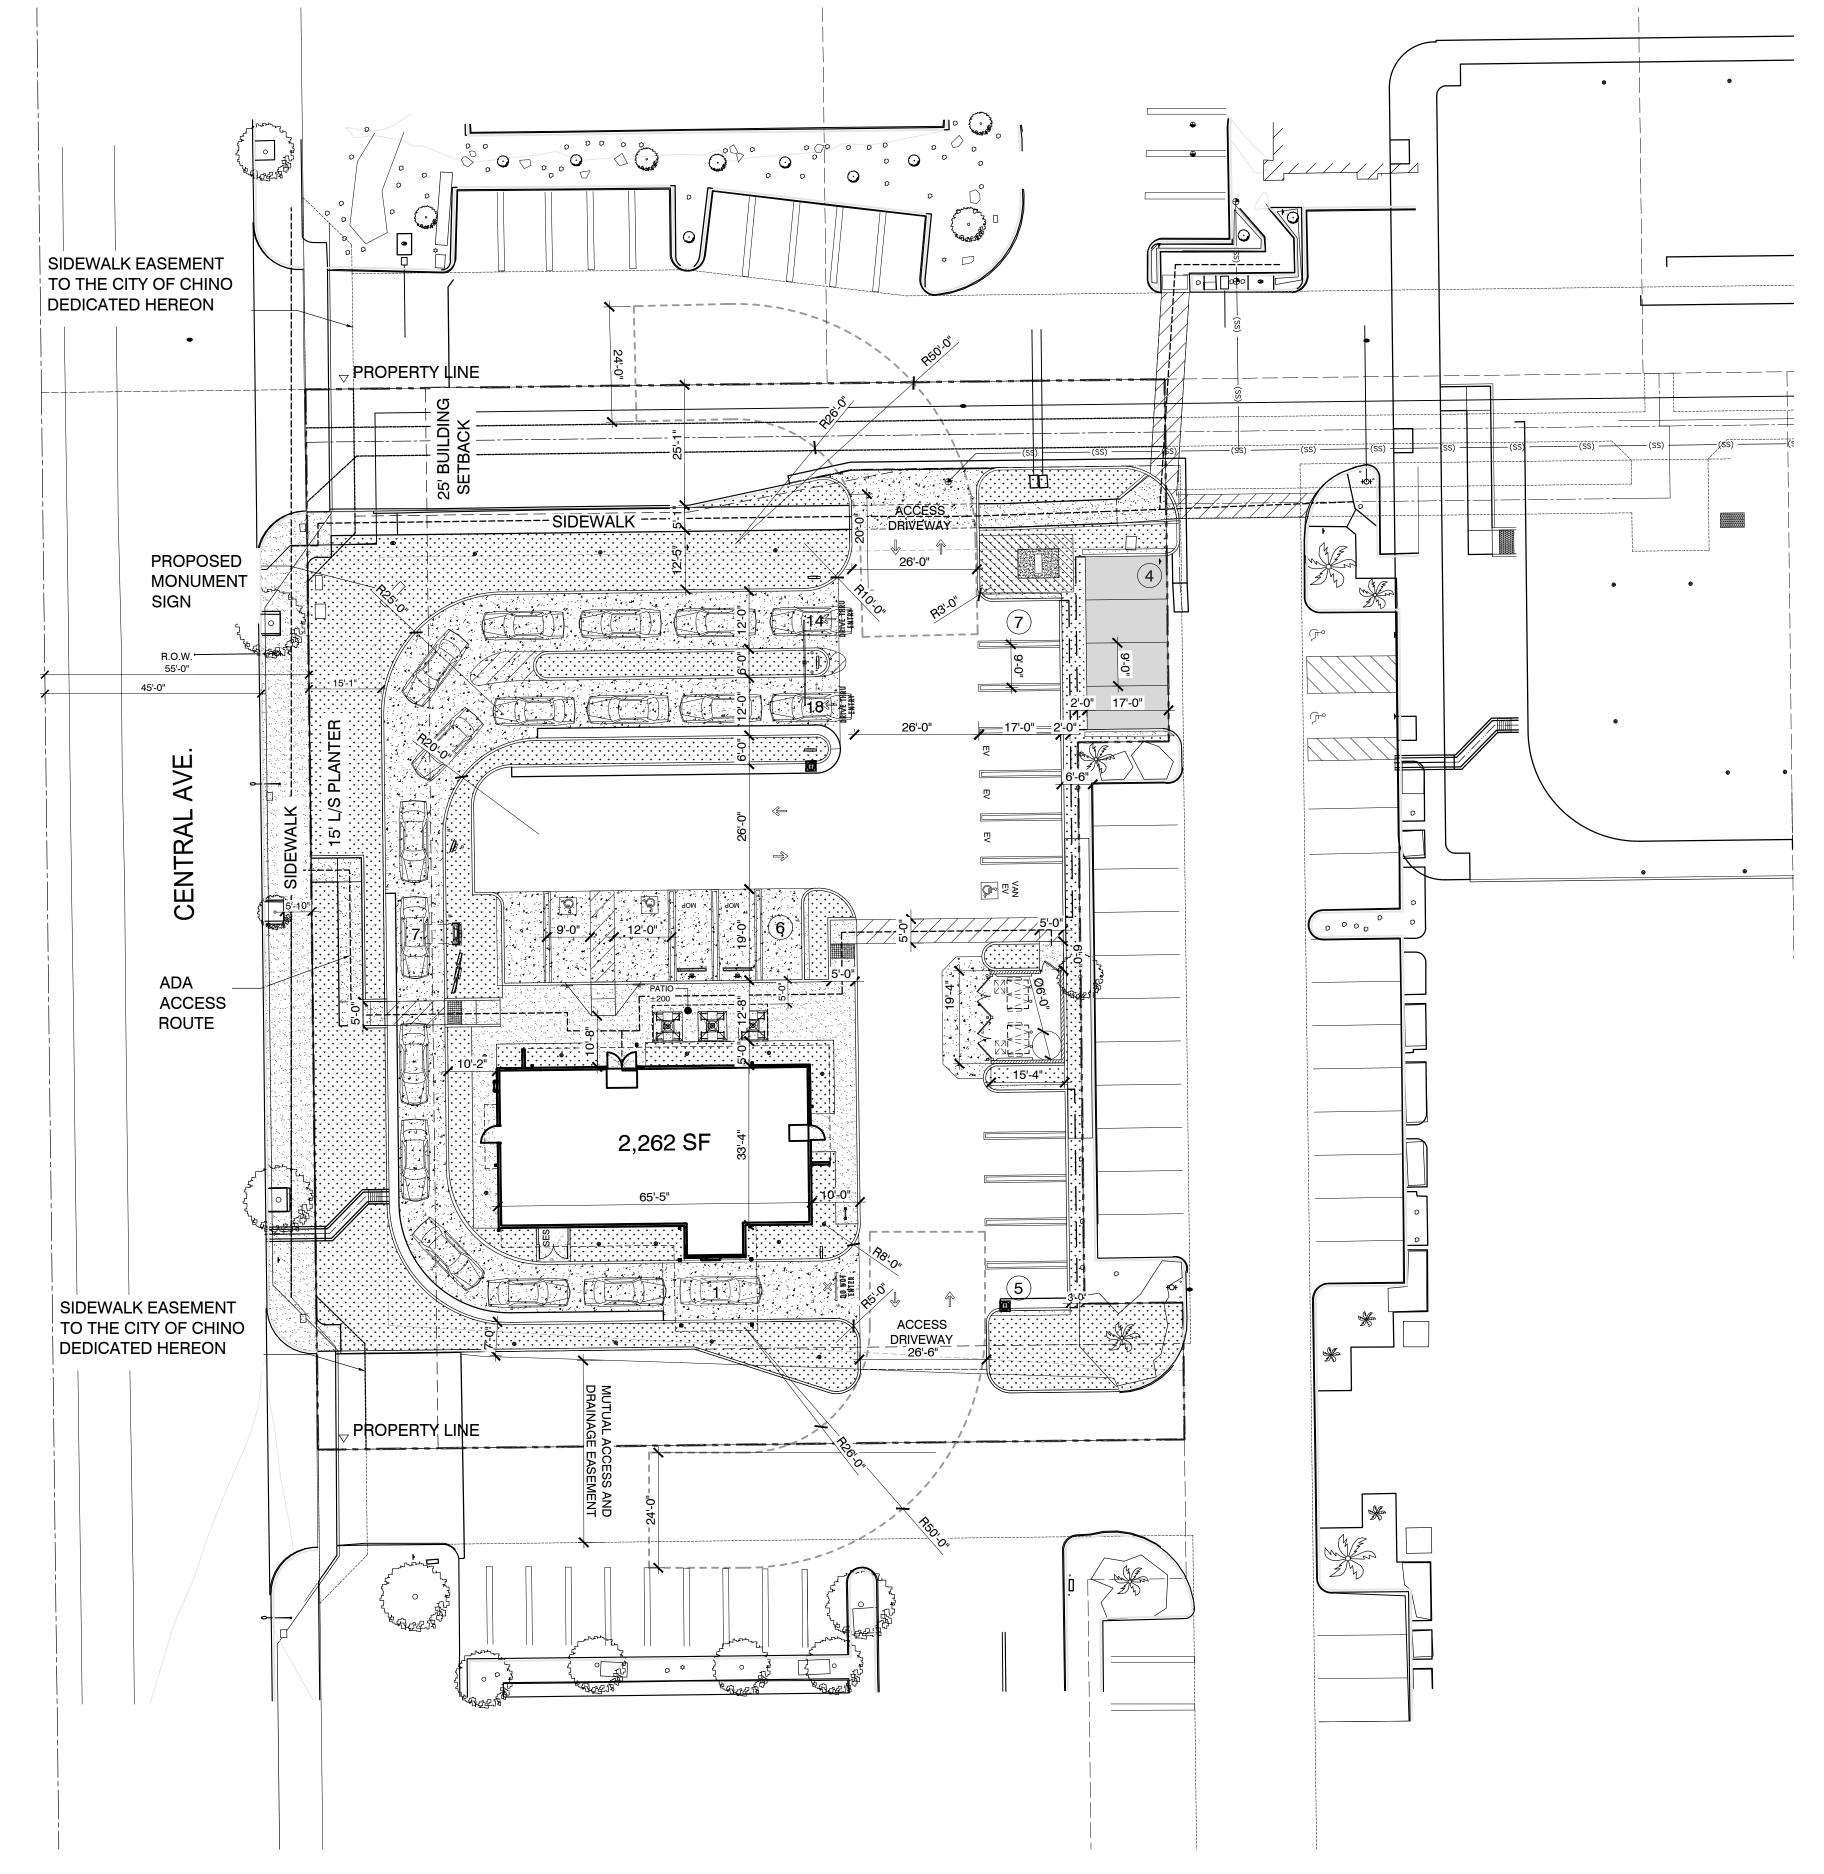

Scale: 1" = 20'

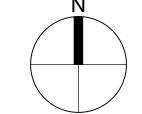

CENTRAL AVE & SCHAEFER AVE CHINO, CA 91710

m c g a r c h i t e c t u r e c c o m SAN FRANCISCO SAN FRANCISCO

PROJECT DIRECTORY

APPLICANT:

STARBUCKS 2401 UTAH AVENUE SOUTH SEATTLE, WA 98134

Tel. No.: (714) 477-2816

MCG ARCHITECTURE
1501 WEST FOUNTAINHEAD PARKWAY, SUITE 321
TEMPE, AZ 85282

Tel. No.: (602) 813-0778
Contact: JORGE CALDERON
E-Mail: JCALDERON@MCGARCHITECTURE.COM

SITE DATA

A.P.N. NO.: 1020-571-12-0-000 EXISTING ZONING: CENTRAL AVENUE SPECIFIC PLAN (CS)

GENERAL PLAN LAND
USE DESIGNATION:

EXISTING DEVELOPMENT:

VACANT LOT

SITE AREA:

(ALLOWABLE 0.6)

GROSSNET (-MINUS RIGHT-OF-WAY
DEDICATIONS)

0.86 ACRES (37,461.6 S.F.)
0.84 ACRES (36,721 S.F.)

LOT COVERAGE 6.2% PROVIDED (MAX ALLOWABLE 45%)

LANDSCAPE COVERAGE: 22.9% PROVIDED

(MINIMUM. 10%)

FLOOR AREA RATIO: .06 PROVIDED

IMPERVIOUS AREA RATIO: .76 PROVIDED
PROPOSED USE: RESTAURANT (DRIVE-THRU)

CONSTRUCTION TYPE: V-B

OCCUPANCY: B

BUILDING AREA: 2,262 SF

PARKING REQUIRED: 10 SPACES
1 SPACE FOR EACH 100 S.F. PUBLIC SEATING AREA. MINIMUM
OF 10 SPACES SHALL BE PROVIDED. (476 SF INDOOR, 200 SF
OUTDOOR). A QUEING LANE SUFFICIENT IN LENGTH TO
ACCOMMODATE 5 VEHICLES AT THE POINT OF FOOD
ORDERING SHALL BE PROVIDED.

PARKING PROVIDED: 22 SPACES

ACCESSIBLE SPACES REQUIRED: 1 SPACE
ACCESSIBLE SPACES PROVIDED: 3 SPACE

BICYCLE PARKING REQUIRED: 1 SPACE

2 SPACES

LANDSCAPED AREA

---> ADA ACCESS PATH

BICYCLE PARKING PROVIDED:

PROJECT SCOPE OF WORK:
PROPOSED NEW DEVELOPMENT OF A 2,262 SF SINGLE STORY
DRIVE-THRU COFFEE SHOP RESTAURANT AND NEW TRASH

LEGAL DESCRIPTION:

ENCLOSURE.

PARCEL 6 OF PARCEL MAP NO. 14905, IN THE CITY OF CHINO, COUNTY OF SAN BERNADINO, STATE OF CALIFORNIA, AS SHOWN ON A MAP RECORDED IN BOOK 190, PAGES 40 THROUGH 43, INCLUSICE OF PARCEL MAPS, IN THE OFFICE OF THE COUNTY RECORDER OF SAID COUNTY.

VICINITY MAP



PEDESTRIAN
ACCESS PLAN

EET NUMBER:

PA-1

©MCG ARCHITECTURE 2025 ALL RIGHTS RESERVED

NOTE: This information is conceptual in nature and is subject to adjustments pending further verification and Client, Tenant, and Governmental Agency approvals. No warranties or guaranties of any kind are given or implied by the Architect.

03/28/2025


24.179.05

REVISIONS

DATE:


MCG JOB #:

DATE

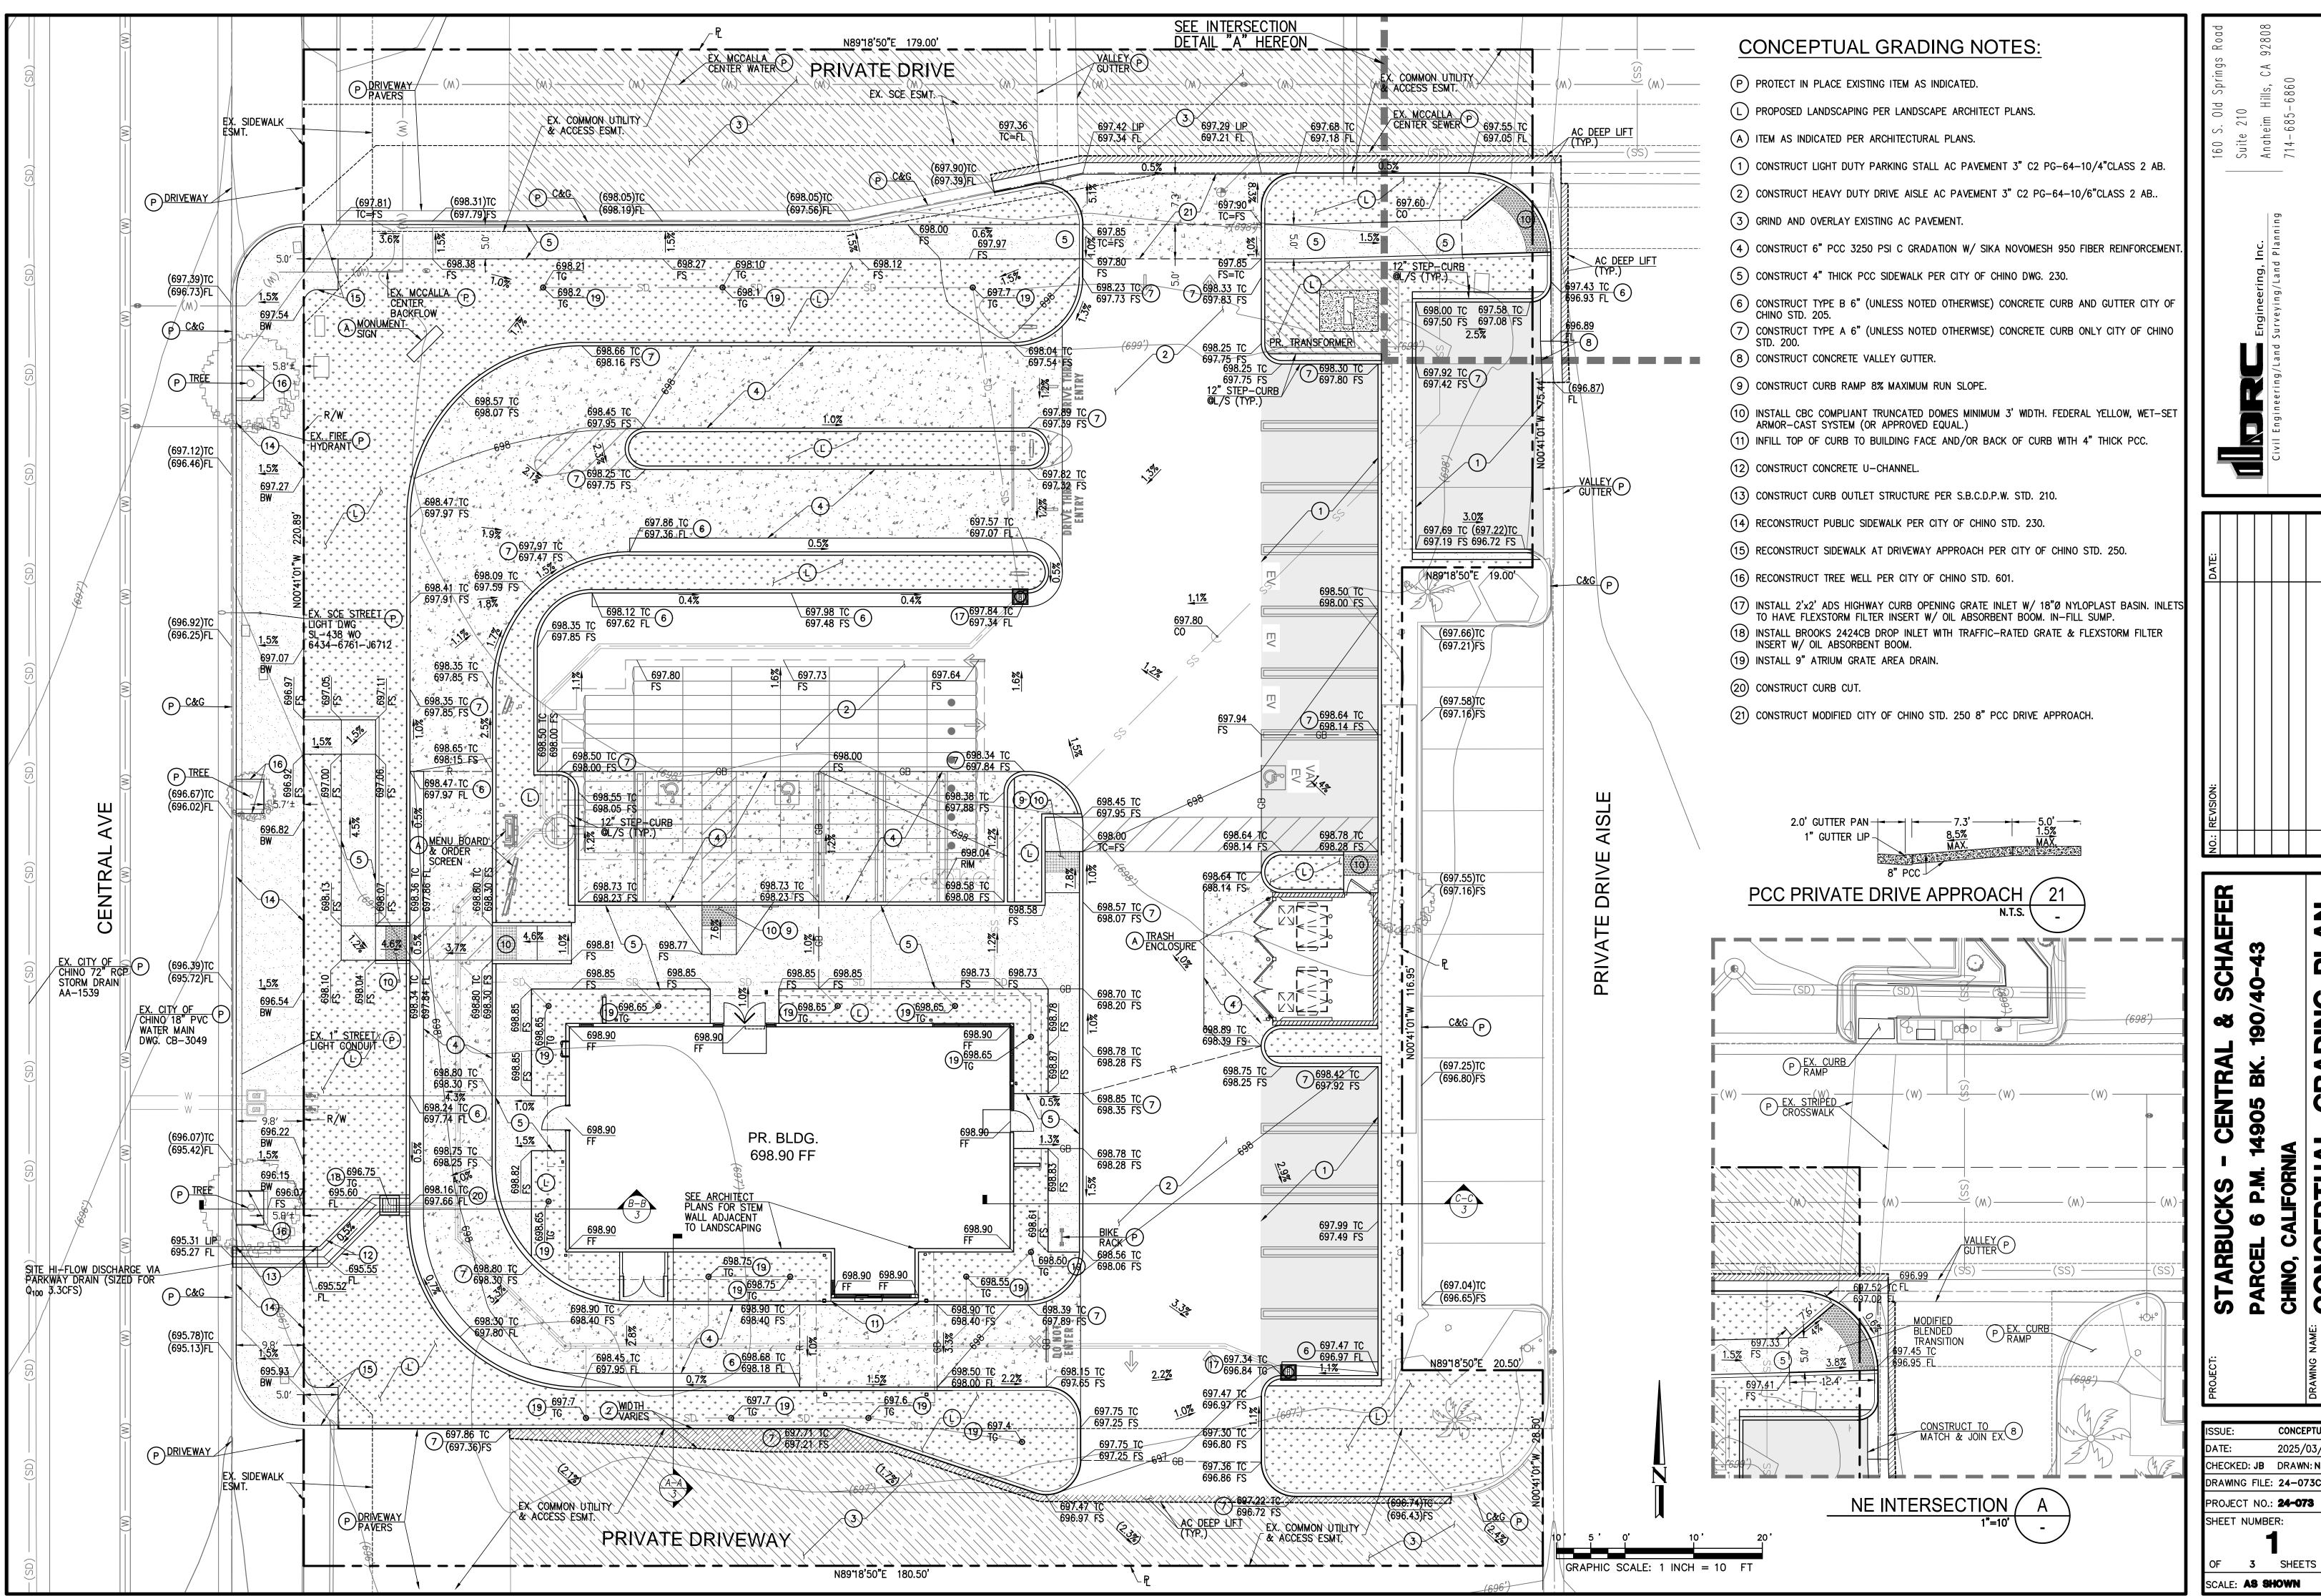

CONCEP

CONCEPTUAL 2025/03/05 CHECKED: JB DRAWN: NS DRAWING FILE: 24-073CG PROJECT NO.: **24-073** SHEET NUMBER:

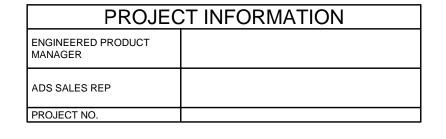

1. CHAMBERS SHALL BE STORMTECH SC-160LP.

WALL STORMWATER COLLECTION CHAMBERS".

IMPEDE FLOW OR LIMIT ACCESS FOR INSPECTION.

FOR IMPACT AND MULTIPLE VEHICLE PRESENCES.

7. REQUIREMENTS FOR HANDLING AND INSTALLATION:

FROM REFLECTIVE GOLD OR YELLOW COLORS.

DELIVERING CHAMBERS TO THE PROJECT SITE AS FOLLOWS:

PIPE TO STANDARD MANIFOLD COMPONENTS IN THE FIELD.

PROPOSED LAYOUT

---- BED LIMITS

LRFD BRIDGE DESIGN SPECIFICATIONS FOR THERMOPLASTIC PIPE.

EXCEPT THAT IT SHALL BE THE 75-YEAR MODULUS USED FOR DESIGN.

COPOLYMERS.

SC-160LP STORMTECH CHAMBER SPECIFICATIONS

2. CHAMBERS SHALL BE ARCH-SHAPED AND SHALL BE MANUFACTURED FROM VIRGIN, IMPACT-MODIFIED POLYPROPYLENE

CHAMBERS SHALL MEET THE REQUIREMENTS OF ASTM F2418, "STANDARD SPECIFICATION FOR POLYPROPYLENE (PP) CORRUGATED

THE STRUCTURAL DESIGN OF THE CHAMBERS, THE STRUCTURAL BACKFILL, AND THE INSTALLATION REQUIREMENTS SHALL ENSURE THAT THE LOAD FACTORS SPECIFIED IN THE AASHTO LRFD BRIDGE DESIGN SPECIFICATIONS, SECTION 12.12, ARE MET FOR: 1)

LONG-DURATION DEAD LOADS AND 2) SHORT-DURATION LIVE LOADS, BASED ON THE AASHTO DESIGN TRUCK WITH CONSIDERATION

6. CHAMBERS SHALL BE DESIGNED, TESTED AND ALLOWABLE LOAD CONFIGURATIONS DETERMINED IN ACCORDANCE WITH ASTM F2787, "STANDARD PRACTICE FOR STRUCTURAL DESIGN OF THERMOPLASTIC CORRUGATED WALL STORMWATER COLLECTION CHAMBERS".

LOAD CONFIGURATIONS SHALL INCLUDE: 1) INSTANTANEOUS (<1 MIN) AASHTO DESIGN TRUCK LIVE LOAD ON MINIMUM COVER 2) MAXIMUM PERMANENT (75-YR) COVER LOAD AND 3) ALLOWABLE COVER WITH PARKED (1-WEEK) AASHTO DESIGN TRUCK.

TO MAINTAIN THE WIDTH OF CHAMBERS DURING SHIPPING AND HANDLING, CHAMBERS SHALL HAVE INTEGRAL, INTERLOCKING

• TO ENSURE A SECURE JOINT DURING INSTALLATION AND BACKFILL, THE HEIGHT OF THE CHAMBER JOINT SHALL NOT BE LESS

GREATER THAN OR EQUAL TO 400 LBS/FT/%. THE ASC IS DEFINED IN SECTION 6.2.8 OF ASTM F2418. AND b) TO RESIST CHAMBER

DEFORMATION DURING INSTALLATION AT ELEVATED TEMPERATURES (ABOVE 73° F / 23° C), CHAMBERS SHALL BE PRODUCED

 THE STRUCTURAL EVALUATION SHALL DEMONSTRATE THAT THE SAFETY FACTORS ARE GREATER THAN OR EQUAL TO 1.95 FOR DEAD LOAD AND 1.75 FOR LIVE LOAD, THE MINIMUM REQUIRED BY ASTM F2787 AND BY SECTIONS 3 AND 12.12 OF THE AASHTO

TO ENSURE THE INTEGRITY OF THE ARCH SHAPE DURING INSTALLATION, a) THE ARCH STIFFNESS CONSTANT SHALL BE

ONLY CHAMBERS THAT ARE APPROVED BY THE SITE DESIGN ENGINEER WILL BE ALLOWED. UPON REQUEST BY THE SITE DESIGN

THE TEST DERIVED CREEP MODULUS AS SPECIFIED IN ASTM F2418 SHALL BE USED FOR PERMANENT DEAD LOAD DESIGN

ADAPTATION OF THIS CHAMBER SYSTEM TO SPECIFIC SITE AND DESIGN CONSTRAINTS, IT MAY BE NECESSARY TO CUT AND COUPLE ADDITIONAL

PROPOSED ELEVATIONS:

11. ADS DOES NOT DESIGN OR PROVIDE MEMBRANE LINER SYSTEMS. TO MINIMIZE THE LEAKAGE POTENTIAL OF LINER SYSTEMS, THE MEMBRANE LINER SYSTEM SHOULD BE DESIGNED BY A KNOWLEDGEABLE GEOTEXTILE PROFESSIONAL AND INSTALLED BY A QUALIFIED CONTRACTOR.

10. MANIFOLD SIZE TO BE DETERMINED BY SITE DESIGN ENGINEER. SEE TECH NOTE #6.32 FOR MANIFOLD SIZING GUIDANCE. DUE TO THE

ENGINEER OR OWNER, THE CHAMBER MANUFACTURER SHALL SUBMIT A STRUCTURAL EVALUATION FOR APPROVAL BEFORE

THE STRUCTURAL EVALUATION SHALL BE SEALED BY A REGISTERED PROFESSIONAL ENGINEER.

9. CHAMBERS AND END CAPS SHALL BE PRODUCED AT AN ISO 9001 CERTIFIED MANUFACTURING FACILITY.

4. CHAMBER ROWS SHALL PROVIDE CONTINUOUS, UNOBSTRUCTED INTERNAL SPACE WITH NO INTERNAL SUPPORTS THAT WOULD





*INVERT ABOVE BASE OF CHAMBER


24-073 REV 1


CHINO, CA, USA IMPORTANT - NOTES FOR THE BIDDING AND INSTALLATION OF THE SC-160LP SYSTEM

- STORMTECH SC-160LP CHAMBERS SHALL NOT BE INSTALLED UNTIL THE MANUFACTURER'S REPRESENTATIVE HAS COMPLETED A PRE-CONSTRUCTION MEETING WITH THE INSTALLERS.
- 2. STORMTECH SC-160LP CHAMBERS SHALL BE INSTALLED IN ACCORDANCE WITH THE "STORMTECH SC-160LP CONSTRUCTION GUIDE".
- EMBEDMENT STONE SURROUNDING CHAMBERS MUST BE A CLEAN, CRUSHED, ANGULAR STONE OR RECYCLED CONCRETE; AASHTO M43 #3, 357, 4, 467, 5, 56, OR 57.
- 4. THE FOUNDATION STONE SHALL BE LEVELED AND COMPACTED PRIOR TO PLACING CHAMBERS.
- THE DEPTH OF FOUNDATION STONE SHALL BE DETERMINED BASED ON THE SUBGRADE BEARING CAPACITY PROVIDED BY THE SITE DESIGN ENGINEER.
- THE CONTRACTOR MUST REPORT ANY DISCREPANCIES CONCERNING CHAMBER FOUNDATION DESIGN AND SUBGRADE BEARING CAPACITIES TO THE SITE DESIGN ENGINEER.
- 7. JOINTS BETWEEN CHAMBERS SHALL BE PROPERLY SEATED PRIOR TO PLACING STONE.
- 8. CHAMBERS SHALL BE INSTALLED "TOE TO TOE". NO ADDITIONAL SPACING BETWEEN ROWS IS REQUIRED.
- 9. STORMTECH RECOMMENDS 3 BACKELL METHODS: STONESHOOTER LOCATED OFF THE CHAMBER BED.
 - BACKFILL AS ROWS ARE BUILT USING AN EXCAVATOR ON THE FOUNDATION STONE OR SUBGRADE. BACKFILL FROM OUTSIDE THE EXCAVATION USING A LONG BOOM HOE OR EXCAVATOR.
- 10. ADS RECOMMENDS THE USE OF "FLEXSTORM CATCH IT" INSERTS DURING CONSTRUCTION FOR ALL INLETS TO PROTECT THE SUBSURFACE STORMWATER MANAGEMENT SYSTEM FROM CONSTRUCTION SITE RUNOFF.

NOTES FOR CONSTRUCTION EQUIPMENT

- THE USE OF CONSTRUCTION EQUIPMENT OVER SC-160LP CHAMBERS IS LIMITED: NO EQUIPMENT IS ALLOWED ON BARE CHAMBERS.
- NO RUBBER TIRED LOADERS, DUMP TRUCKS, OR EXCAVATORS ARE ALLOWED UNTIL PROPER FILL DEPTHS ARE REACHED IN ACCORDANCE. WITH THE "STORMTECH SC-160LP CONSTRUCTION GUIDE". • WEIGHT LIMITS FOR CONSTRUCTION EQUIPMENT CAN BE FOUND IN THE "STORMTECH SC-106LP CONSTRUCTION GUIDE".
- 2. FULL 36" (900 mm) OF STABILIZED COVER MATERIALS OVER THE CHAMBERS IS REQUIRED FOR DUMP TRUCK TRAVEL OR DUMPING.
- CONTACT STORMTECH AT 1-800-821-6710 WITH ANY QUESTIONS ON INSTALLATION REQUIREMENTS OR WEIGHT LIMITS FOR CONSTRUCTION EQUIPMENT.

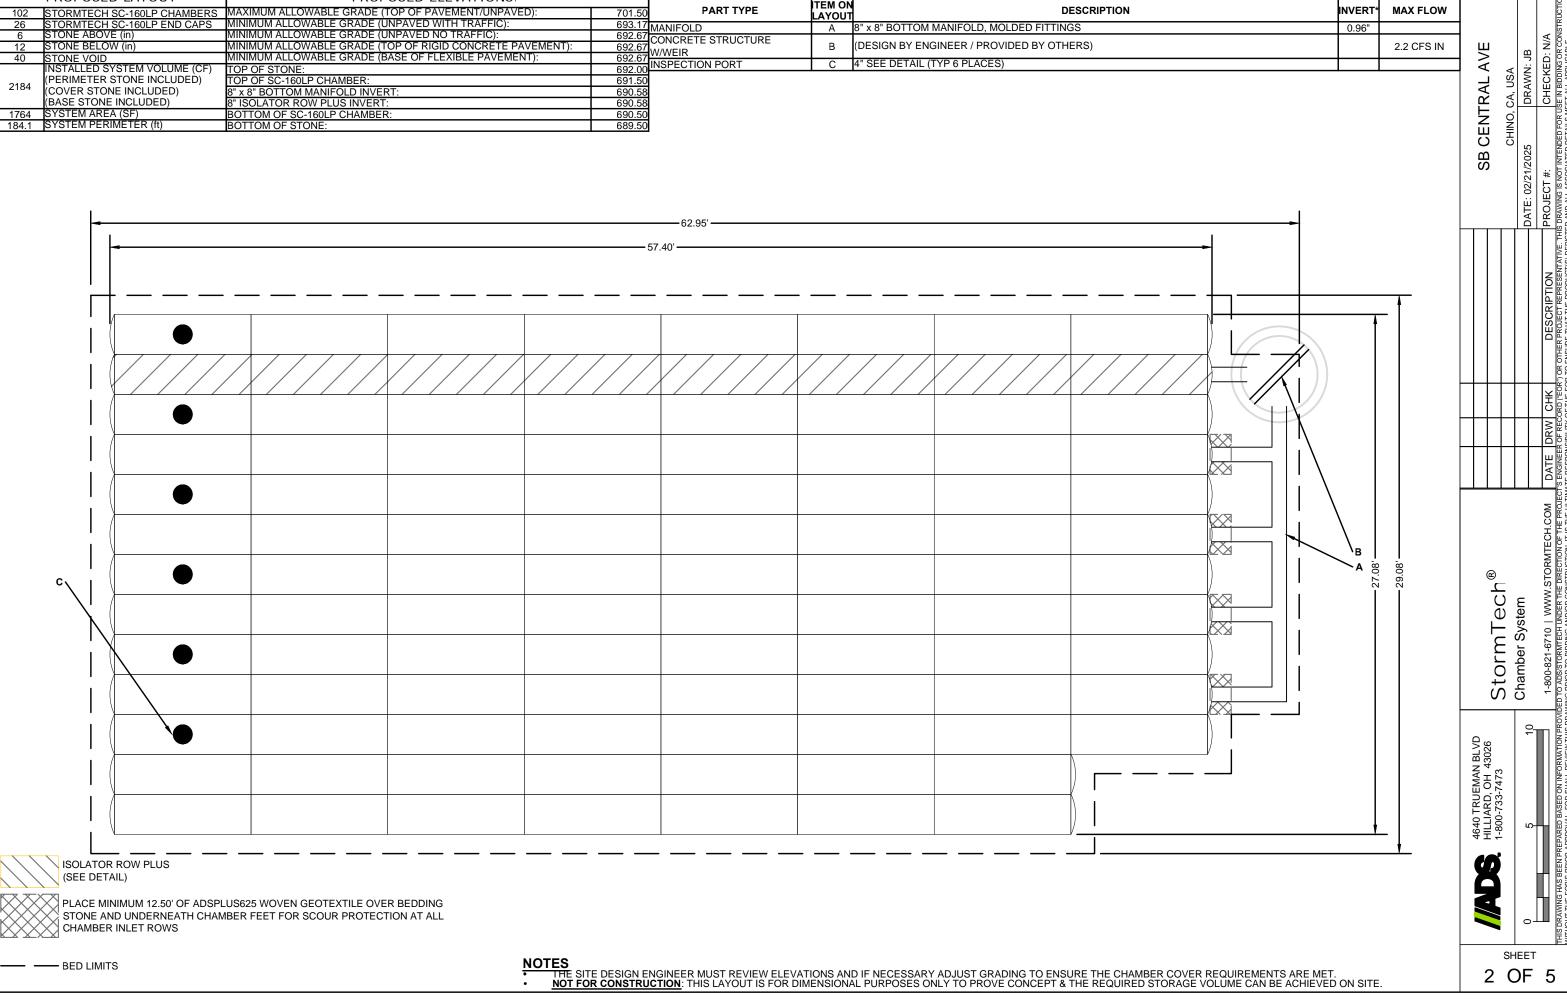

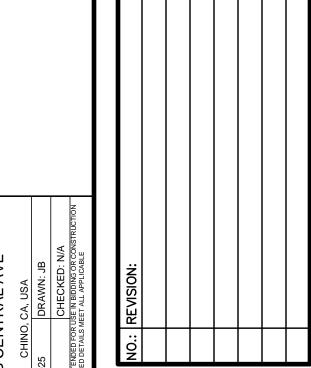


CONCEPTUAL 2025/02/20 CHECKED: JB DRAWN: NS DRAWING FILE: 24-073CG

2 OF 5

PROJECT NO.: **24-073** SHEET NUMBER: OF **3** SHEETS


CALE: AS SHOWN

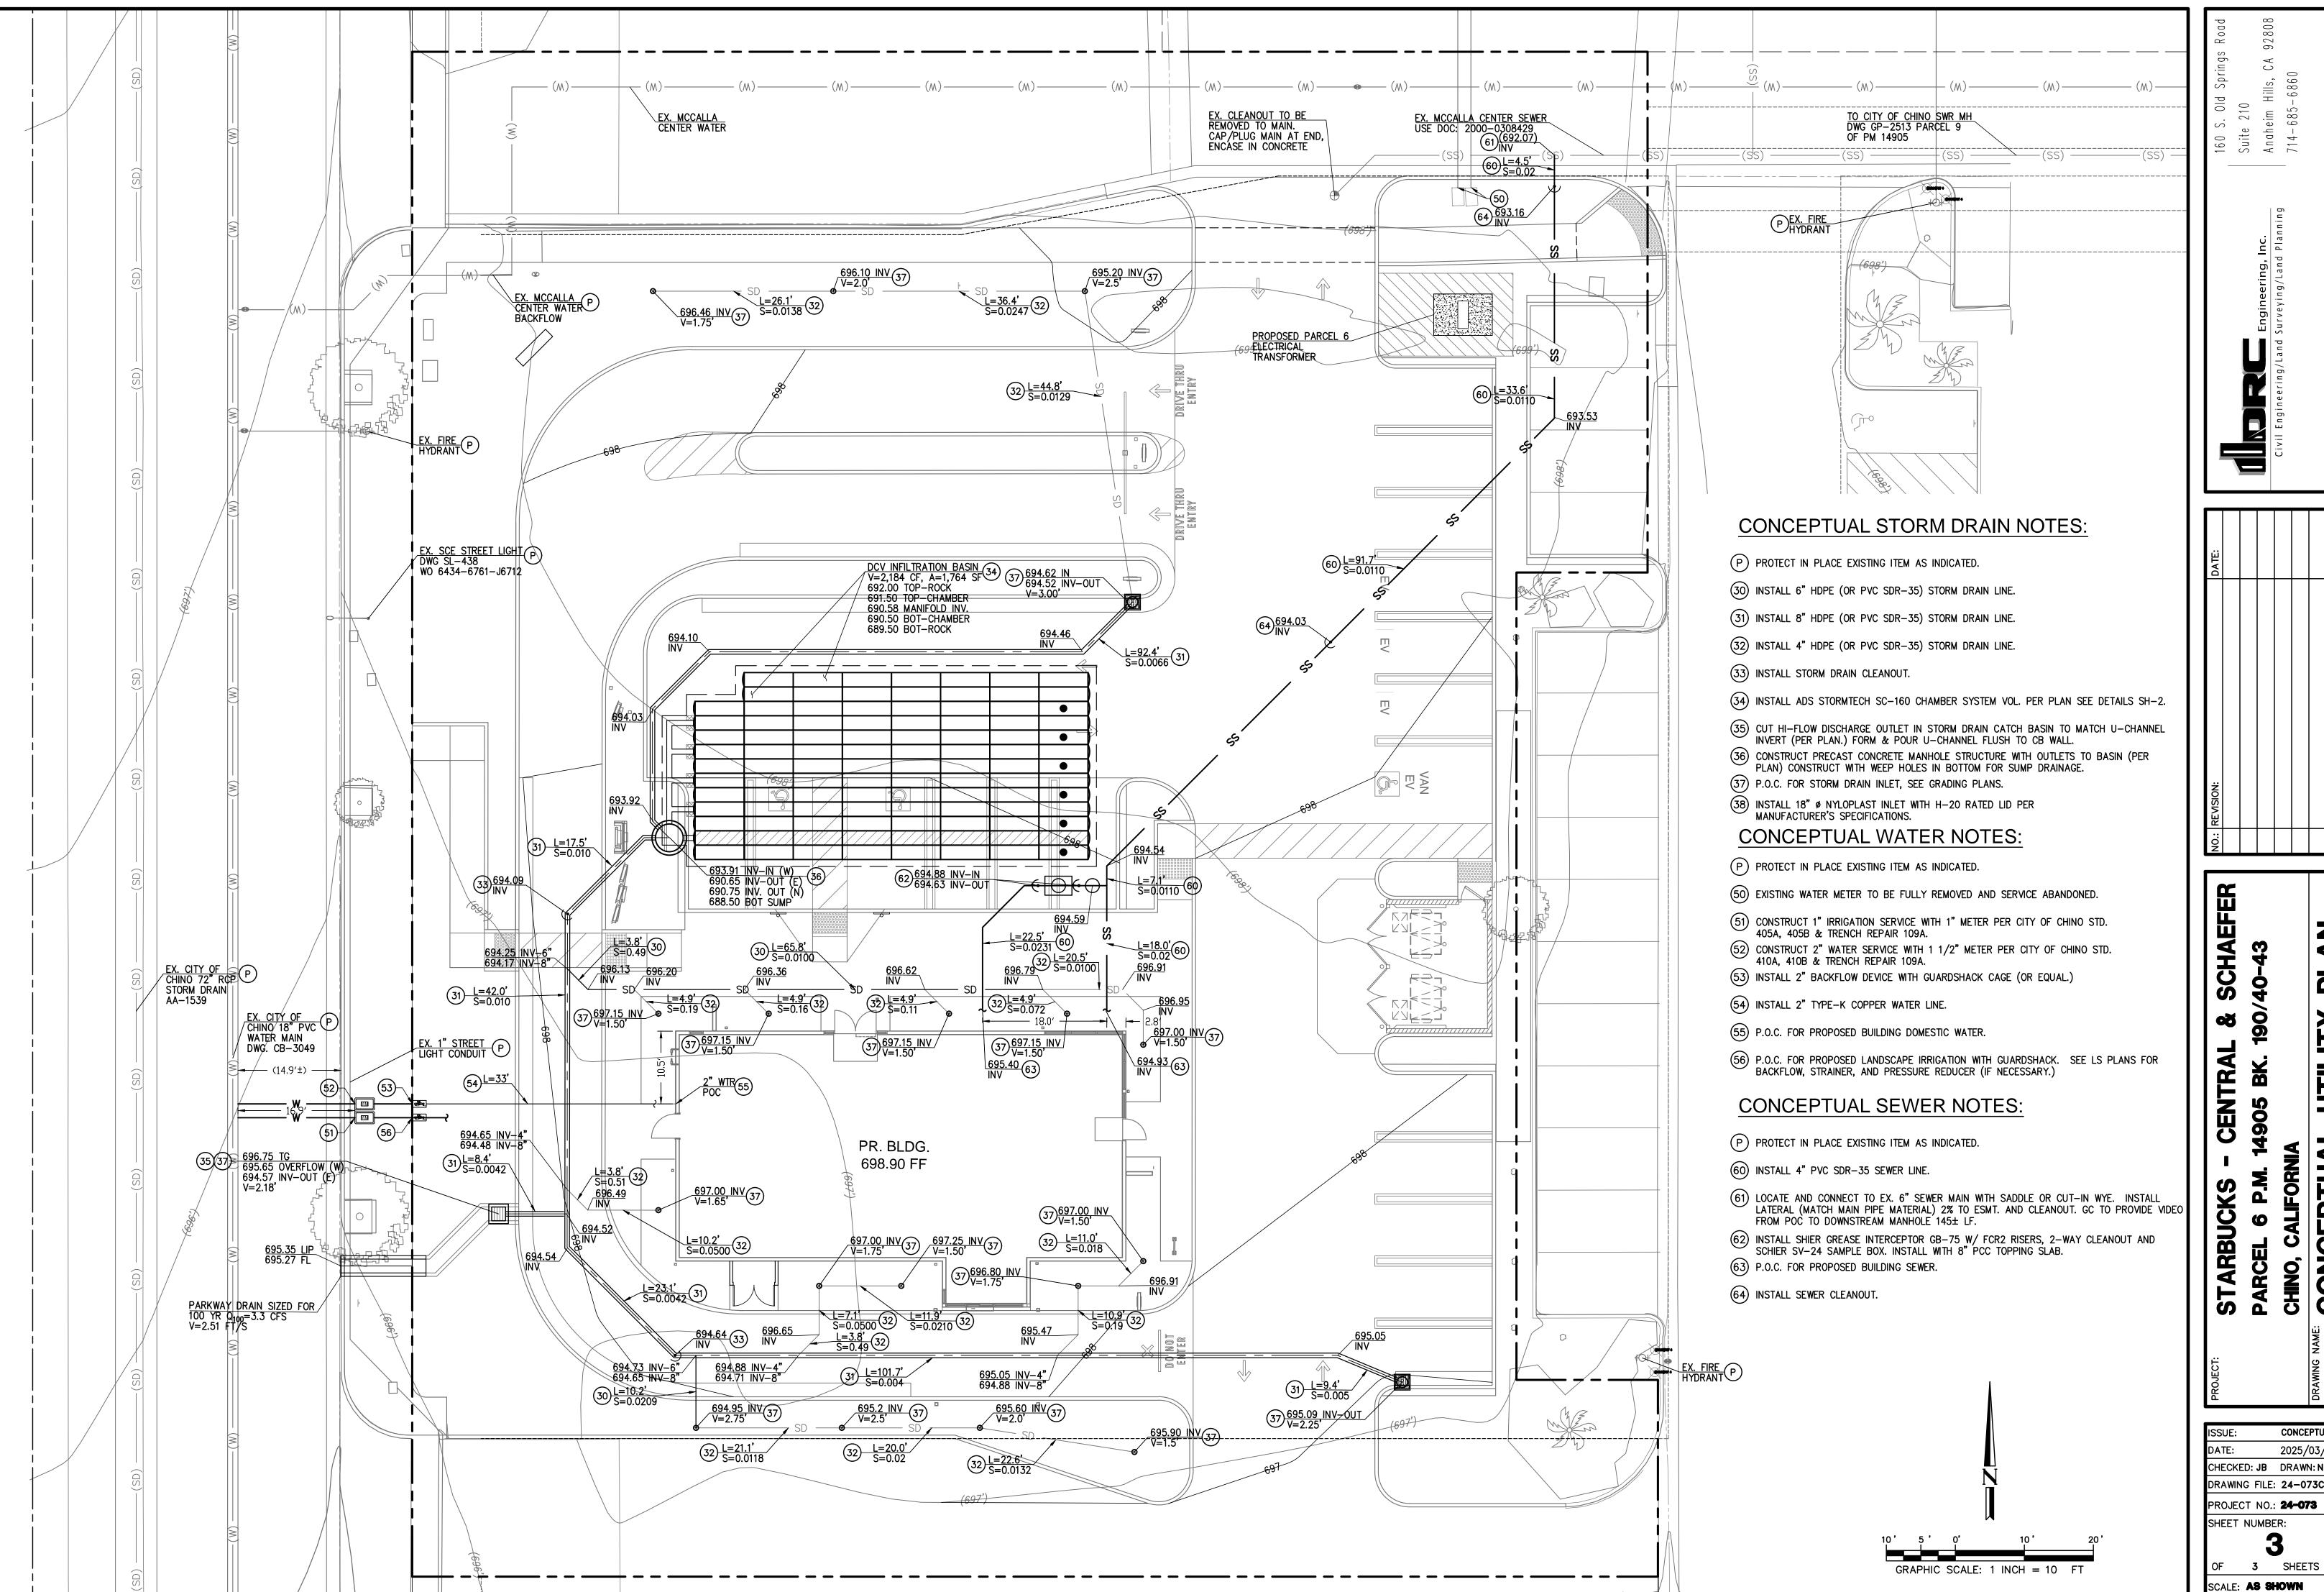

CHINO,

CONCEPTUAL 2025/03/05

CHECKED: JB DRAWN: NS DRAWING FILE: 24-073CU PROJECT NO.: **24-073** SHEET NUMBER:

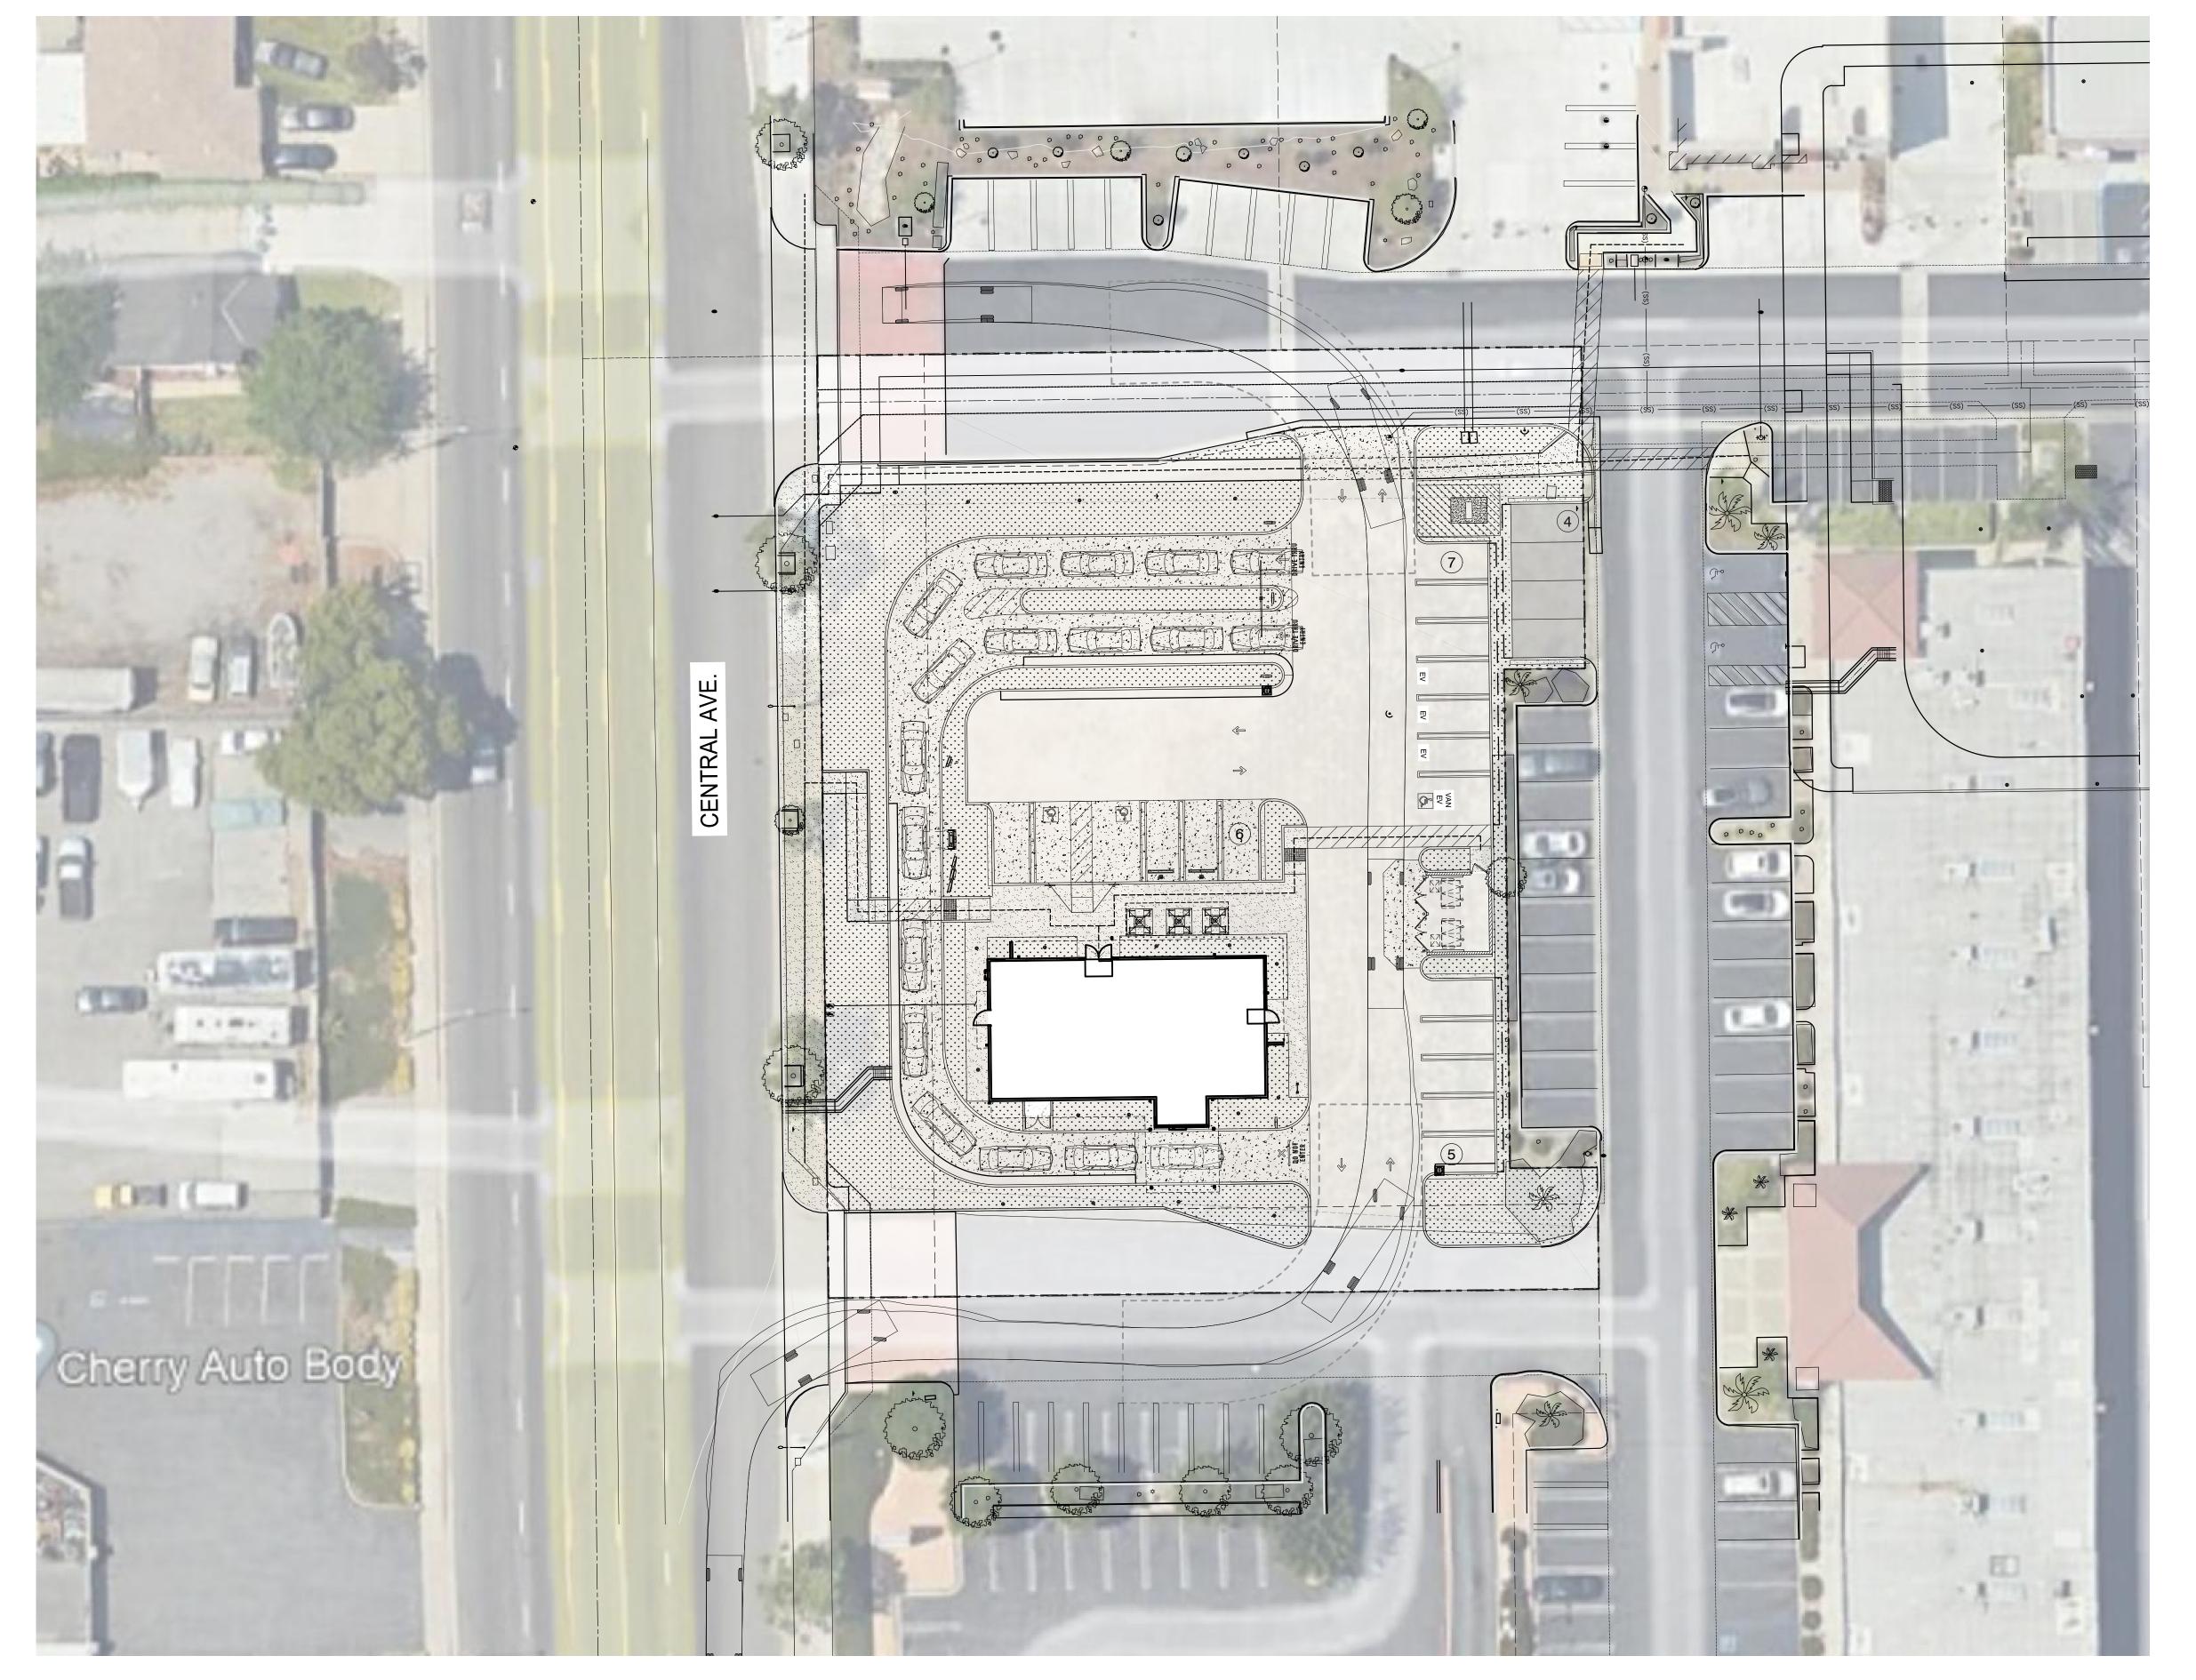

CENTRAL AVE & SCHAEFER AVE CHINO, CA 91710

m c g a r c h i t e c t u r e . c o m SAN FRANCISCO SAN FRANCISCO

SHEET TITLE: SITE PLAN - TRUCK TURNING TEMPLATE

SP-1

PROJECT DIRECTORY

STARBUCKS

TEMPE, AZ 85282
Tel. No.: (602) 813-0778
Contact: JORGE CALDERON

EXISTING ZONING: CENTRAL AVENUE SPECIFIC PLAN (CS)

1 SPACE FOR EACH 100 S.F. PUBLIC SEATING AREA. MINIMUM OF 10 SPACES SHALL BE PROVIDED. (476 SF INDOOR, 200 SF OUTDOOR). A QUEING LANE SUFFICIENT IN LENGTH TO ACCOMMODATE 5 VEHICLES AT THE POINT OF FOOD

SEATTLE, WA 98134 Tel. No.: (714) 477-2816

2401 UTAH AVENUE SOUTH

MCG ARCHITECTURE

1501 WEST FOUNTAINHEAD PARKWAY, SUITE 321

E-Mail: JCALDERON@MCGARCHITECTURE.COM

1020-571-12-0-000

VACANT LOT

6.2% PROVIDED

22.9% PROVIDED

.06 PROVIDED

.76 PROVIDED

2,262 SF

22 SPACES

1 SPACE

3 SPACE

1 SPACE

2 SPACES

GENERAL COMMERCIAL

0.86 ACRES (37,461.6 S.F.)

0.84 ACRES (36,721 S.F.)

RESTAURANT (DRIVE-THRU)

APPLICANT:

SITE DATA

GENERAL PLAN LAND USE DESIGNATION:

EXISTING DEVELOPMENT:

NET (-MINUS RIGHT-OF-WAY

A.P.N. NO.:

SITE AREA:

DEDICATIONS)

LOT COVERAGE

(MINIMUM. 10%)

(ALLOWABLE 0.6)

PROPOSED USE:

OCCUPANCY:

BUILDING AREA:

PARKING REQUIRED:

PARKING PROVIDED:

ENCLOSURE.

VICINITY MAP

ORDERING SHALL BE PROVIDED.

ACCESSIBLE SPACES REQUIRED:

ACCESSIBLE SPACES PROVIDED:

— → ADA ACCESS PATH

LANDSCAPED AREA

PROPOSED NEW DEVELOPMENT OF A 2,262 SF SINGLE STORY DRIVE-THRU COFFEE SHOP RESTAURANT AND NEW TRASH

PARCEL 6 OF PARCEL MAP NO. 14905, IN THE CITY OF CHINO, COUNTY OF SAN BERNADINO, STATE OF CALIFORNIA, AS SHOWN ON A MAP RECORDED IN BOOK 190, PAGES 40 THROUGH 43, INCLUSICE OF PARCEL MAPS, IN THE OFFICE OF

BICYCLE PARKING REQUIRED:

BECHEN PARKING PROVIDED:

FLOOR AREA RATIO:

(MAX ALLOWABLE 45%)

LANDSCAPE COVERAGE:

IMPERVIOUS AREA RATIO:

CONSTRUCTION TYPE:


04/15/2025 24.179.05 REVISIONS

DATE REVISIONS

DATE:

MCG JOB #:

©MCG ARCHITECTURE 2025 ALL RIGHTS RESERVED NOTE: This information is conceptual in nature and is subject to adjustments pending further verification and Client, Tenant, and Governmental Agency approvals. No warranties or guaranties of any kind are given or implied by the Architect.

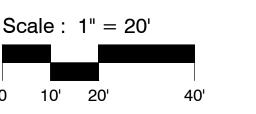

N