ADDRESS SIGN, INTERNALLY ILLUMINATED, LOW VOLTAGE, PROVIDE TIMER BUILDING SHALL HAVE ADDRESS NUMBERS PLACED IN A POSITION THAT IS PLAINLY LEGIBLE AND VISIBLE FROM THE STREET OR ROAD FRONTING THE PROPERTY. NUMBERS SHALL CONTRAST WITH BACKGROUND, BE ARABIC OR ALPHABETICAL LETTERS AND BE A MINIMUM OF 4" HIGH WITH A MINIMUM STROKE OF 1/2". (R319.1 CRC)

NOTE:

1. LOTS SHALL BE GRADED TO DRAIN SURFACE WATER AWAY FROM THE FOUDATION WALLS, THE GRADE SHALL FALL A MINIMUM OF 6" WITHIN THE FIRST 10' (5%) WHERE LOT LINES, WALLS, SLOPE OR OTHER PHYSICAL BARRIER PROHIBIT 6" OF FALL WITHIN 10' DRAINS OR SWALES SHALL BE CONSTRUCTED TO ENSURE DRAINAGE AWAY FROM THE STRUCTURE [CRC R401.3]

2. IMPERVIOUS SURFACES WITHIN 10' OF THE BUILDING FOUNDATION SHALL BE SLOPED A MINIMUM OF 2% AWAY FROM THE BUILDING [CRC R401.3 EXCEPTION]

THERE SHALL BE NO TRENCHES OR EXCAVATIONS 5 FEET OR MORE IN DEPTH INTO WHICH A PERSON IS required to descend; or obtain a necessary permit from state of california, division of INDUSTRIAL SAFETY PRIOR TO THE ISSUANCE OF A BUILDING OR GRADING PERMIT.

1. ALL CONSTRUCTION SHALL CONFORM TO THE CURRENT EDITION OF THE CALIFORNIA BUILDING CODE AND ALL APPLICABLE CODES ORDINANCES AND REGULATIONS.

2. GENERAL CONTRACTOR TO VERIFY EXISTING CONDITIONS PRIOR TO CONSTRUCTION. 3. MICHAEL D. CARPENTER SHALL BE INFORMED IN WRITTING OF ANY DISCREPANCY PRIOR

GREEN BUILDING CODE REQUIREMENTS

mechanical equipment is to be covered. CGC 4.504.1.

outside and controlled by a humidistat. CGC 4.506.1.

approval. California Green Building Standards Code Section 301.1.1.

Composition Wood Products. CGC 4.504.2.

flow rate less than 0.8 gpm at 20 psi.

CGC 4.410.1.

CALIFORNIA RESIDENTIAL GREEN BUILDING STANDARDS

1. Indoor water use. Show compliance with the following table for new/replaced fixtures, per CGC 4.303.1.

FIXTURE FLOW RATES FIXTURE TYPE MAXIMUM FLOW RATE Water closets 1.28 gallons/flush

2. Recycling. A minimum of 65% of construction waste is to be recycled. CGC 4.408.1.

3. Recycling. The contractor shall submit a Construction Waste Management Plan to

4. Operation and maintenance manual. The builder is to provide an operation manual

5. Pollutant control. During construction, ends of duct openings are to be sealed, and

6. Pollutant control. VOC's must comply with the limitations listed in Section 4.504.3

7. Interior moisture control. The moisture content of wood shall not exceed 19% before

8. Indoor air quality. Bathroom fans shall be Energy Star rated, vented directly to the

the jurisdiction agency that regulates waste management, per CGC 4.408.2.

Showerheads 1.8 gpm @ 80 psi, Lavatory faucets 1.2 gpm @ 60 psi, Lavatory faucets shall not have a

(containing information for maintaining appliances, etc.) for the owner at the time of final inspection.

and Tables 4.504.1, 4.504.2, 4.504.3 and 4.504.5 for: Adhesives, Paints and Coatings, Carpet and

it is enclosed in construction. The moisture content needs to be certified by one of 3 methods specified in

Section 4.505.3. Building materials with visible signs of water damage should not be used in construction.

9. Prior to final inspection the licensed contractor in responsible charge of the overall construction must

10.Existing "noncompliant" fixtures (toilets that use more than 1.6 gallons of water per flush, urinals that

use more than one gallon of water per flush, showerheads that have a flow capacity of more than 2.5 gallons of water per minute, and interior faucets that emit more than 2.2 gallons of water per minute) shall be replaced. Certification of compliance shall be given to the building inspector prior to final permit

Building Standards Code have been implemented as part of the construction. CGC 102.3.

The moisture content must be determined by the contractor by one of the methods listed in CGC 4.505.3.

provide to the building department official written verification that all applicable provisions from the Green


TO CONSTRUCTION.

THERE IS NOT TO BE ANY BODY OF WATER 18" OR DEEPER ON THE PROPERTY UNLESS ALL SWIMMING POOL SAFETY BARRIERS ARE COMPLIED WITH.

THE DISCHARGE OF POLUTANTS TO ANY STORM DRAINAGE SYSTEM IS PROHIBITTED, NO SOLID WASTE, PETROLEUM BY PRODUCTS, SOIL PARTICULATE, CONSTUCTION WASTE MATERIALS OR WASTE WATER GENERATED ON CONSTUCTION SITES OR BY CONSTRUCTION ACTIVITIES SHALL BE PLACED, CONVEYED OR DISCHARGED IN TO THE STREET, GUTTER OR STORM DRAIN SYSTEM.


THIS PROJECT SHALL COMPLY WITH THE 2022 EDITION OF THE CALIFORNIA BUILDING CODE, THE 2022 CALIFORNIA RESIDENTIAL CODE AND THE 2022 CALIFORNIA GREEN BUILDING STANDARDS CODE

NO GRADING IS PROPOSED FOR THIS PROJECT, EXCAVATIONS BELOW EXISTING FINISHED GRADE ARE FOR FOOTINGS FOR THE CONSTRUCTION OF A BUILDING ONLY AND WILL BE AUTHORIZED BY A BUILDING PERMIT.

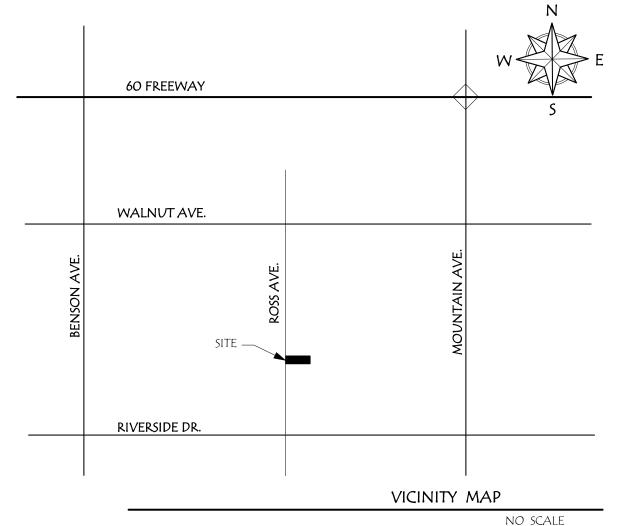



EXISTING RESIDENCE

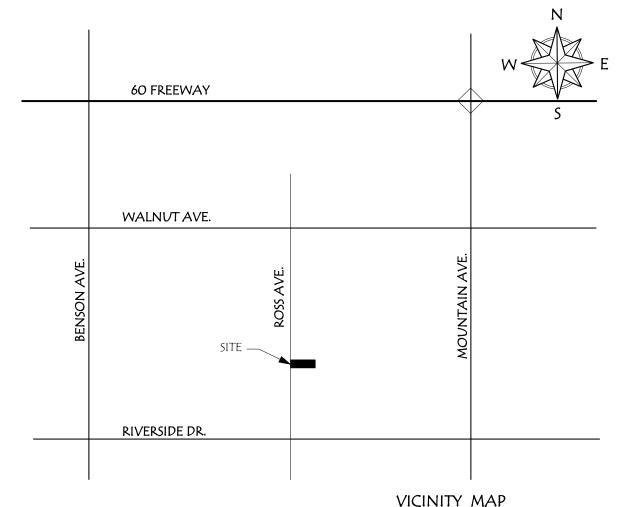



DRAWINGS ISSUED FOR:

5-27-25 SCUP SUBMITTAL NO. 2



MICHAEL D. CARPENTER

CARPENTER



BUILDING DESIGN SERVICES

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CARPENTERDESIGNS@AOL.COM

SCOPE OF WORK:

1. PROPOSED DETACHED RV GARAGE = 1,600 SQUARE FEET

2. CONCRETE AND CONCRETE PAVER DRIVEWAY TO RV GARAGE DOORS 3. 6' HIGH CMU WALL, 244 L.F.

PROJECT DATA

TENBERGE RV GARAGE

3150

BUILDING SIZE, FOOTPRINT 1,908 S.F. LIVABLE + GARAGE

8.05 %

1955

ONE

TWO CAR GARAGE

BUILDING SIZE, FOOTPRINT 3,508 S.F. LIVABLE + GARAGE + RV GARAGE

14.80 %

1,132 S.F.

776 S.F.

1,600 S.F.

CITY OF CHINO

23,700 S.F. (0.54 ACRE)

16' E. RESIDENCE, 20' PROPOSED RV GARAGE

TWO CAR GARAGE + TWO BAY RV GARAGE

2022 CALIFORNIA BUILDING CODE

2022 CALIFORNIA RESIDENTIAL CODE

2022 CALIFORNIA ELECTRIC CODE

2022 CALIFORNIA PLUMBING CODE

2022 CALIFORNIA BUILDING CODE

2022 CALIFORNIA ENERGY CODE

2022 CALIFORNIA FIRE CODE

2022 CALIFORNIA MECHANICAL CODE

2022 CALIFORNIA EXISTING BUILDING CODE

ALL APPLICABLE CITY, COUNTY AND STATE.

2022 CALIFORNIA GREEN BUILDING STANDARDS CODE

1015-531-29-0000

RD-2

R-3, U1

12795 ROSS AVE, CHINO, CA. 91710

23,700 S.F. (0.54 ACRE)

GREGORY AND KIMBERLY TENBERGE 12795 ROSS AVE, CHINO, CA. 91710

EXISTING STRUCTURE - NO, PROPOSED RV GARAGE - NO

PROJECT

OWNER

JOB LOCATION

LEGAL DESCRIPTION

LOT

TRACT

A.P.N.

PROJECT DATA

ZONE

SITE DATA

existing

LOT SIZE

LOT COVERAGE

YEAR BUILT

BED ROOMS

Parking

PROPOSED

LOT SIZE

Parking

AREA TABULATION

existing:

LIVABLE

PROPOSED:

JURISDICTION

GARAGE

RV GARAGE

GOVERNING CODES

Building

ELECTRICAL

PLUMBING

ENERGY

Building

Building

ORDINANCES

FIRE

BUILDING C.B.C.

MECHANICAL C.M.C.

ACCESSABILITY C.B.C.

C.R.C.

C.E.C.

C.P.C.

C.B.C.

C.B.C.

C.B.C.

C.B.C.

LOT COVERAGE

NUMBER OF STORIES

BUILDING HEIGHT

BATH ROOMS

NUMBER OF STORIES

BUILDING HEIGHT

OCCUPANCY

FIRE SPRINKLERS

TYPE OF CONSTRUCTION

BUILDING SIZE, LIVABLE

SHEET INDEX

COVER SHEET SITE UTILIZATION PLAN SITE PLAN

FLOOR PLAN exterior elevations

EXTERIOR ELEVATIONS COLORED

THIS PROJECT SHALL COMPLY WITH THE 2022 EDITION OF THE CALIFORNIA BUILDING CODE, THE 2022 CALIFORNIA RESIDENTIAL CODE AND THE 2022 CALIFORNIA GREEN BUILDING STANDARDS CODE

A 5 ROOF PLAN CROSS SECTIONS Α6

PROJECT:

TENBERGE RV GARAGE

12795 ROSS AVE. CHINO, CA. 91710


SHEET DESCRIPTION:


SITE PLAN

SCALE: AS NOTED SHEET NUMBER:



PROPOSED RV GARAGE

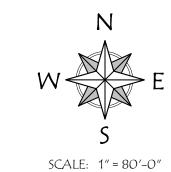

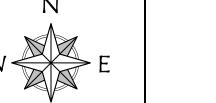

MICHAEL D. CARPENTER

DRAWINGS ISSUED FOR:

CARPENTER




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60 FREEWAY

WALNUT AVE.

RIVERSIDE DR.

VICINITY MAP

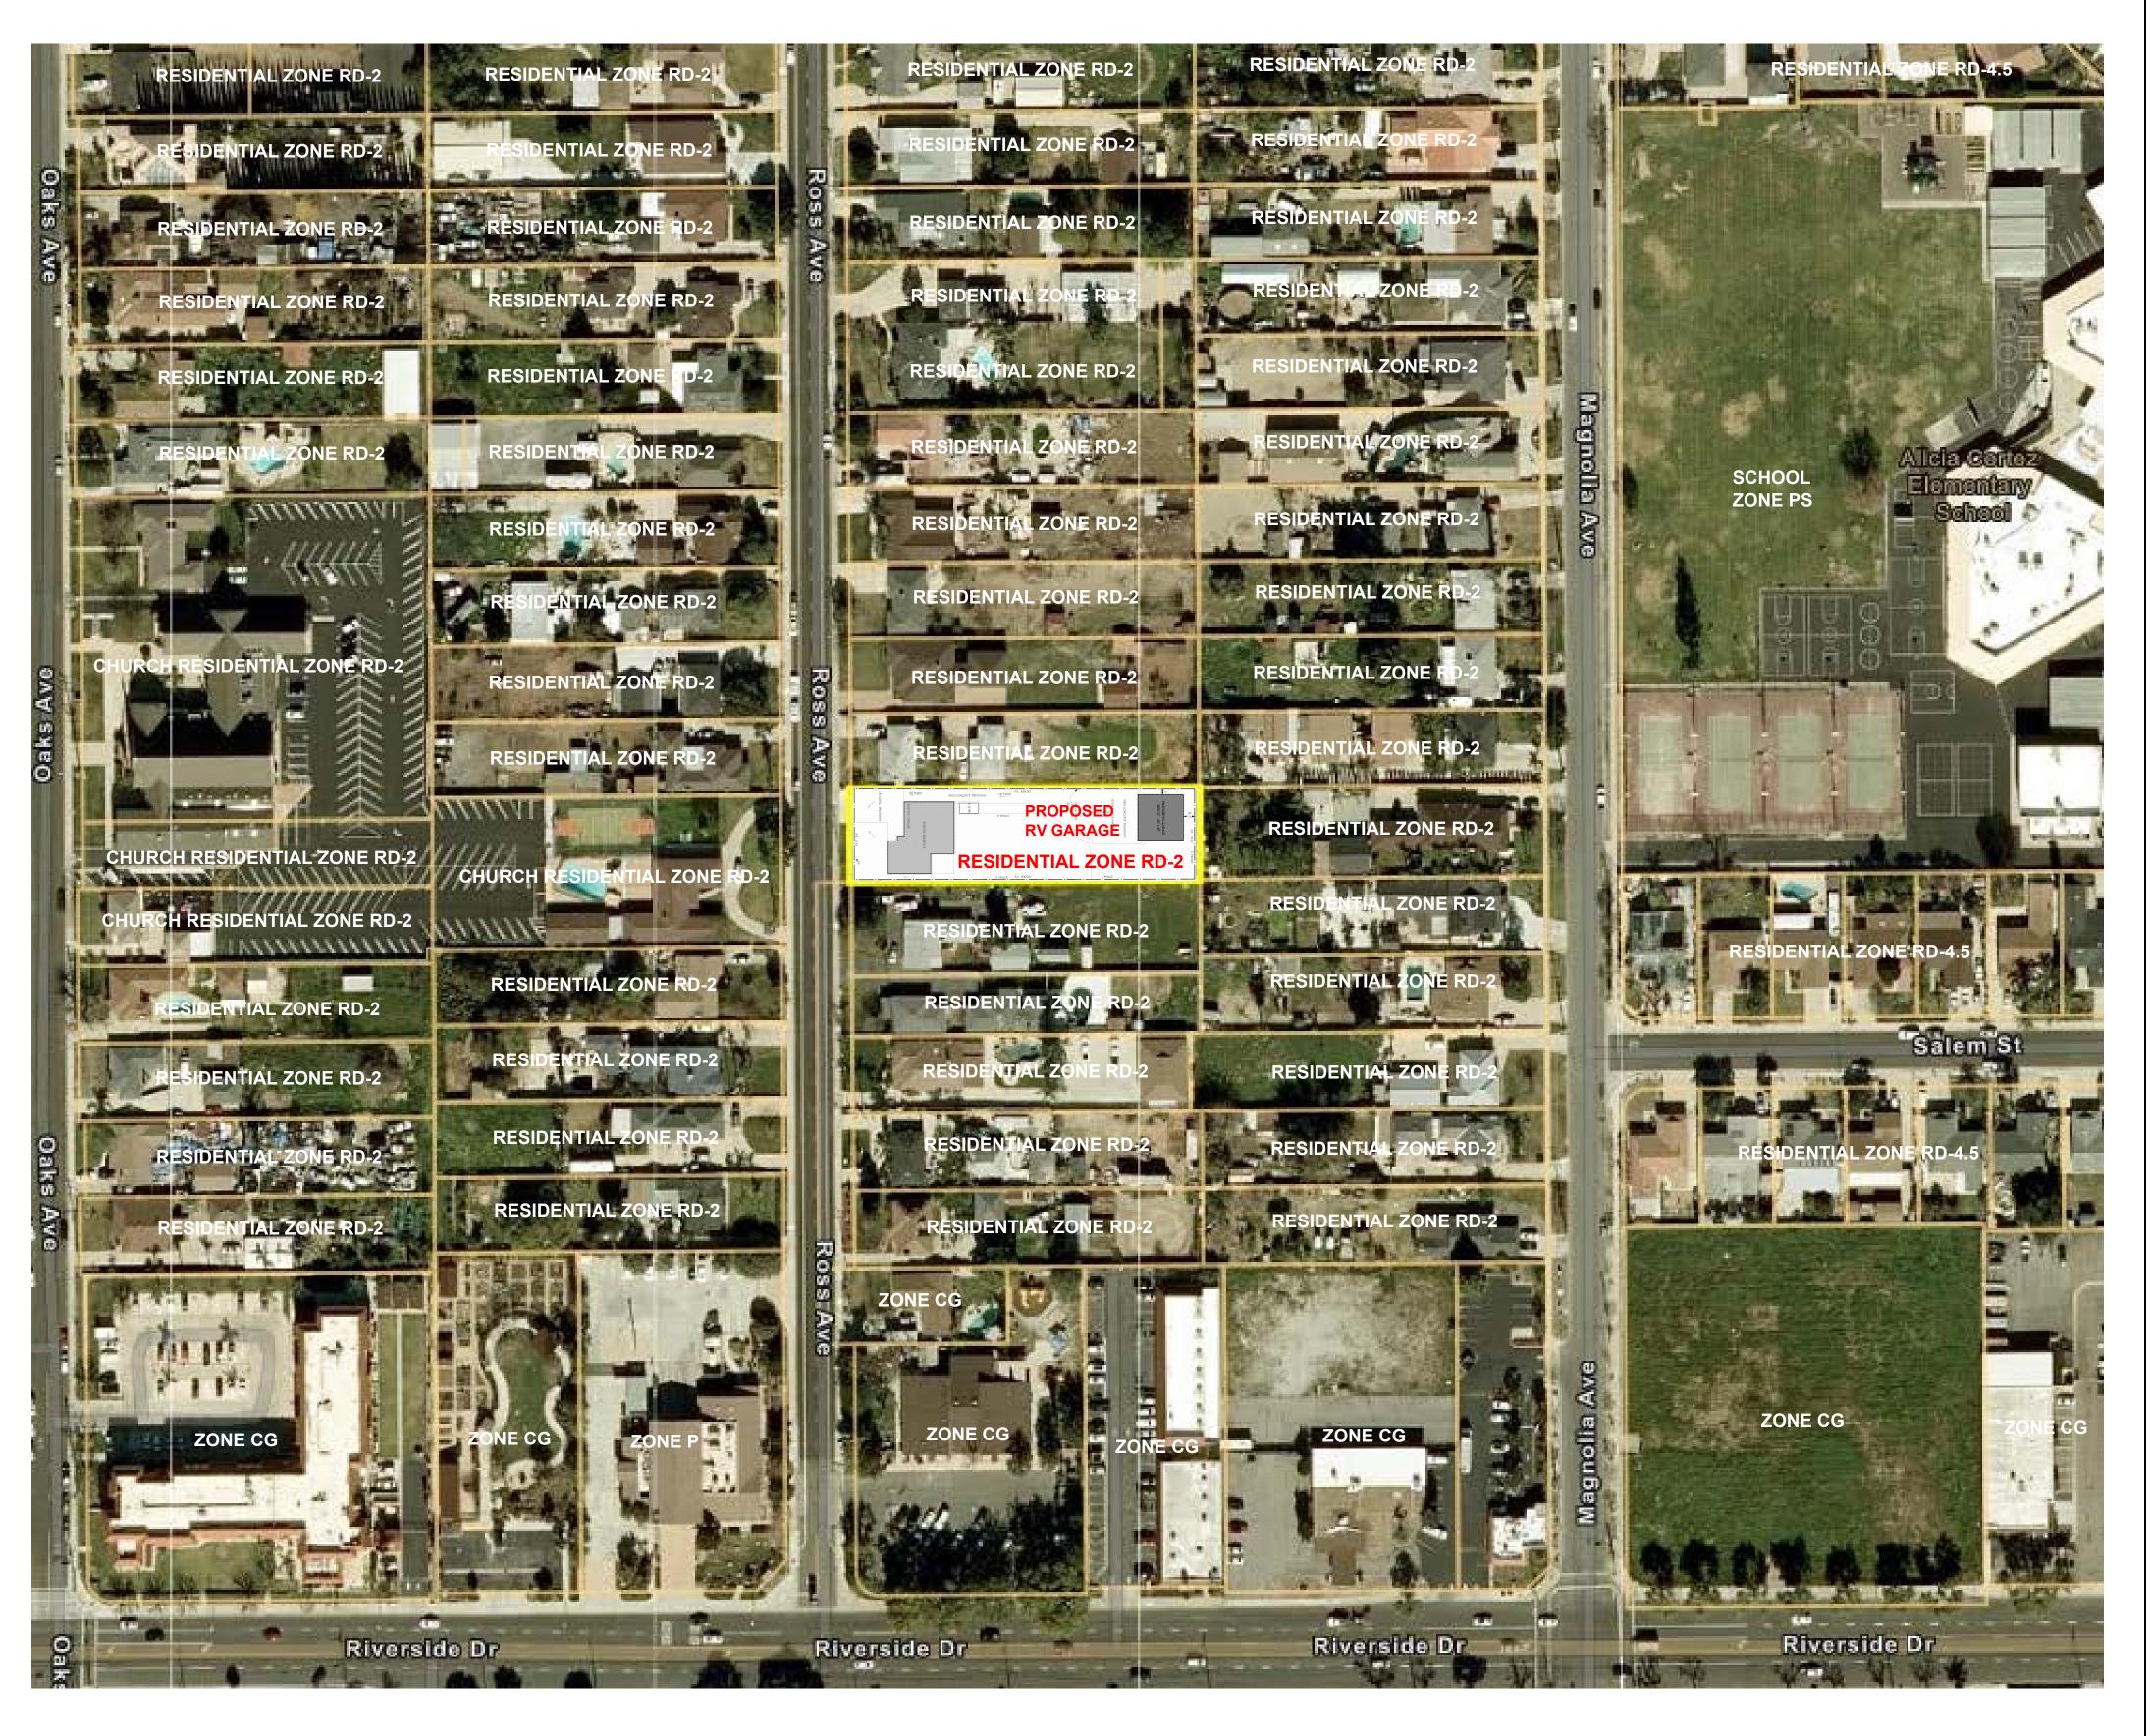NO SCALE

1:4,514
0 0.03 0.06 0.12 mi
0 0.05 0.1 0.2 km

County of San Bernardino, Maxar, Microsoft, Esri Community Maps
Contributors, County of Los Angeles, County of Riverside, County of San SITE RD2

PROJECT:

TENBERGE RV GARAGE


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SHEET DESCRIPTION:

SITE UTILIZATION PLAN

SCALE: AS NOTED

SHEET NUMBER:

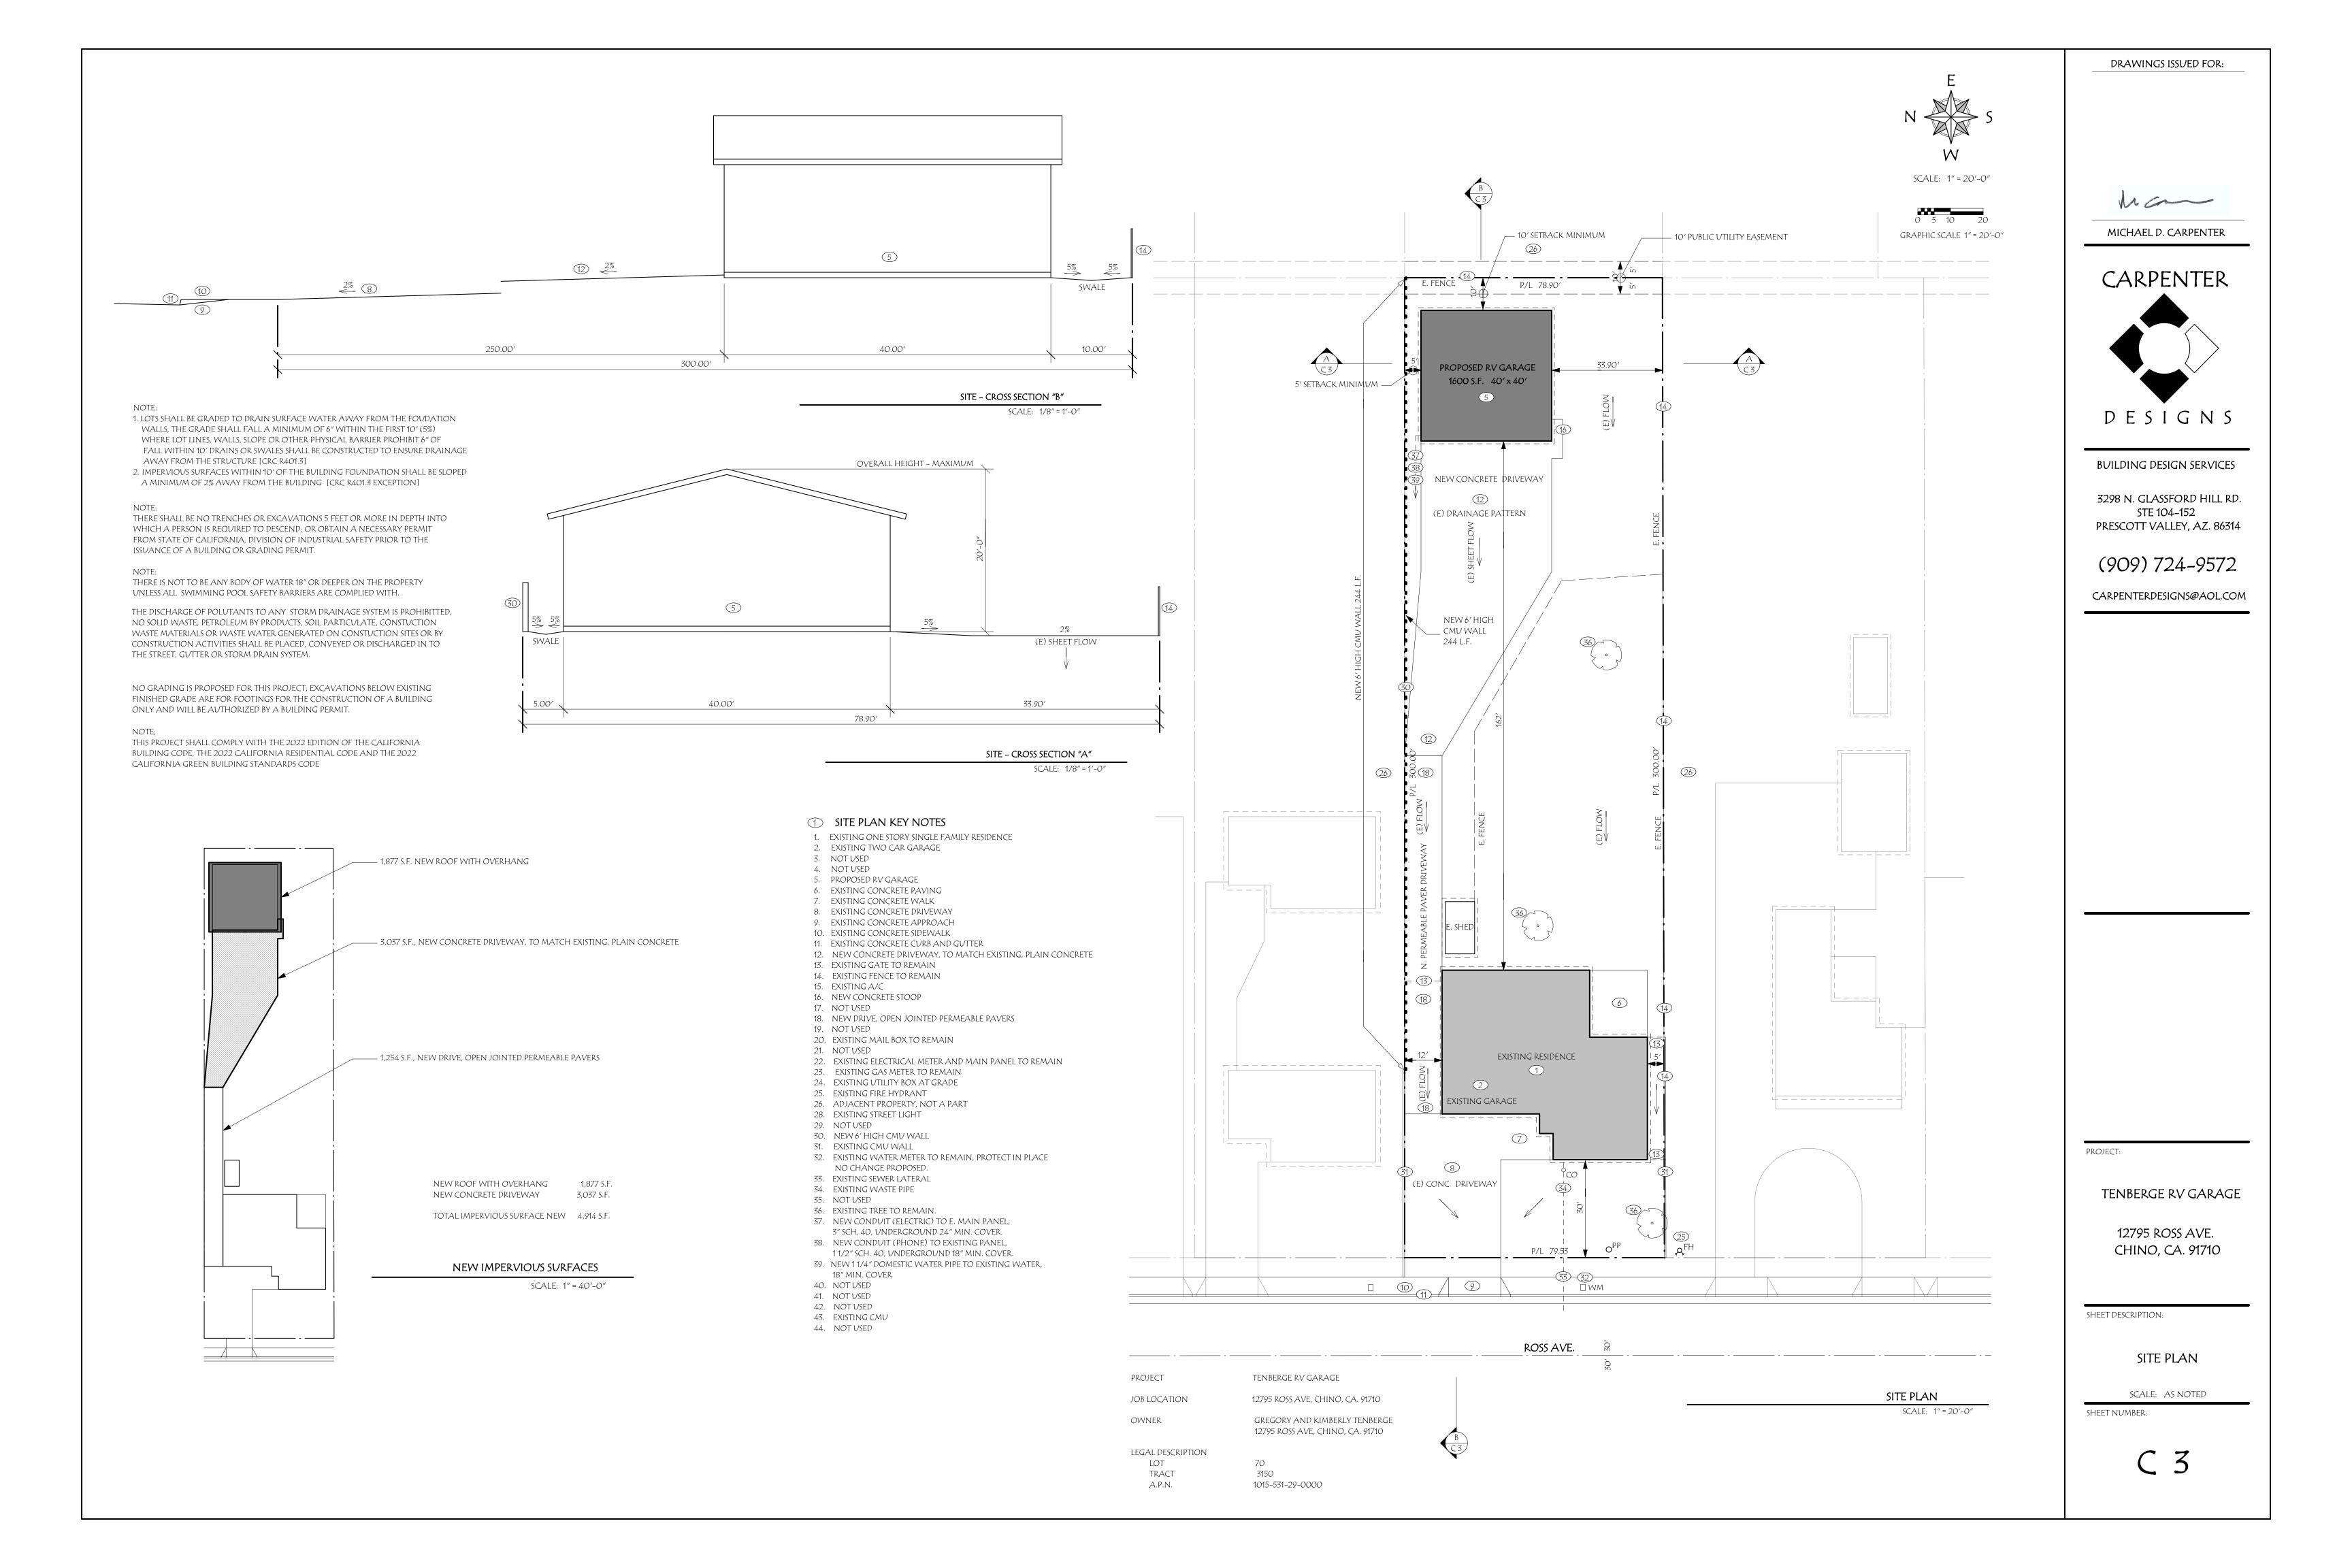

WINDOW AND DOOR NOTES:

EGRESS WINDOWS

- PROVIDE EMERGENCY ESCAPE FROM NEW BED ROOMS AND BASEMENTS, THE ESCAPE OPENING SHALL HAVE A MINIMUM NET CLEAR OPENING OF 5.7 SQUARE FEET WITH 24" MIN. NET CLEAR HEIGHT AND 20" MIN.
- NET CLEAR WIDTH, ESCAPE WINDOW SHALL HAVE A FINISHED SILL HEIGHT NOT MORE THAN 44" ABOVE THE FLOOR GLAZING NOTE:
- * NEW WINDOWS AND FRENCH DOORS TO BE DUAL GLAZE LOW "E" UNLESS NOTED OTHERWISE
- * THE LOAD RESISTANCE OF GLASS UNDER UNIFORM LOAD SHALL BE DETERMINED IN ACCORDANCE WITH ASTM E 1300.
- * ANY INDIVIDUAL PANE OF GLASS OVER 9 SQUARE FEET, WITHIN 18" OF THE FLOOR, TOP EDGE OF GLASS IS 36" ABOVE FLOOR AND WALKING SURFACE IS WITHIN 36" SHALL BE FULLY TEMPERERD.
- * ANY GLASS IN DOORS, SIDELITES OR WINDOWS WITHIN 24" OF THE STIKE EDGE OF ANY DOOR SHALL BE FULLY TEMPERED.
- * EACH PANE OF SAFETY GLAZING INSTALLED IN HAZARDOUS LOCATIONS SHALL BE IDENTIFIED (ACID ETCHED, SAND BLASTED, CERAMIC FIRED, ETC.) BY A MANUFACTURER'S DESIGNATION, THE MANUFACTURER OR INSTALLER AND THE SAFETY GLAZING STANDARD WHICH IT COMPLIES.
- * ALL NEW GLAZING SHALL BE INSTALLED WITH LABELS TO REMAIN IN PLACE FOR INSPECTION.

FINISH NOTE: WALL AND CEILING FINISH MATERIALS SHALL HAVE A FLAME SPREAD CLASSIFICATION OF NOT GREATER THAN 200, AND A SMOKE DEVELOPED INDEX OF NOT GREATER THAN 450. CRC SECTION R302.9

RESIDENTIAL GREEN BUILDING STANDARDS

EXISTING "NONCOMPLIANT" FIXTURES (TOILETS THAT USE MORE THAN 1.6 GALLONS OF WATER PER FLUSH, URINALS THAT USE MORE THAN ONE GALLON OF WATER PER FLUSH, SHOWERHEADS THAT HAVE A FLOW CAPACITY OF MORE THAN 2.5 GALLONS OF WATER PER MINUTE, AND INTERIOR FAUCETS THAT EMIT MORE THAN 2.2 GALLONS OF WATER PER MINUTE) SHALL BE REPLACED. CERTIFICATION OF COMPLIANCE SHALL BE GIVEN TO THE BUILDING INSPECTOR PRIOR TO FINAL PERMIT APPROVAL.

RESIDENTIAL GREEN BUILDING STANDARDS

EFFECTIVE JAN. 1, 2017 RESIDENTIAL BUILDINGS UNDERGOING ADDITIONS, ALTERATIONN OR IMPROVEMENTS SHALL REPLACE NONCOMPLIANCE PLUMBING FIXTURES WITH WATER CONSERVING PLUMBING FIXTURES PRIOR TO FINAL INSPECTION. THE REQUIREMENTS SHALL APPLY TO NEW FIXTURE IN ADDITIONS OR AREAS OF ALTERATION TO THE BUILDING (PER 2019 CAL GREEN SECTIONS 301.1.1, 4.303.1.1 - 4.303.1.4.4 & 2019 CPC SECTIONS 403.0 - 403.8

FLOOR PLAN GENERAL NOTES

- 1. THE CONTROL VALVES IN SHOWERS, BATHTUBS, AND BIDETS MUST BE PRESSURE BALANCED OR THERMOSTATIC MIXING VALVES.
- 2. BATHTUB AND SHOWER FLOORS AND WALLS TO HAVE WATER RESISTANT NON ABSORBENT FINISH TO 72" ABOVE SHOWER FLOOR. IF ENCLOSURES ARE PROVIDED, THEY SHALL BE SHATTER PROOF (TEMPERED GLASS) CEMENT, FIBER-CEMENT, FIBER-MAT REINFORCED CEMENT, GLASS MAT GYPSUM OR FIBER-REINFORCED GYPSUM BACKERS SHALL BE USED AS A BASE FOR WALL
- TILE IN TUB AND SHOWER AREAS AND WALL AND CEILING PANELS IN SHOWER AREAS. 3. PROVIDE EMERGENCY ESCAPE FROM BED ROOMS, THE ESCAPE OPENING SHALL HAVE A MINIMUM NET CLEAR OPENING OF 5.7 SQUARE FEET WITH 24" MIN. NET CLEAR HEIGHT AND 20" MIN. NET CLEAR WIDTH, ESCAPE WINDOW SHALL HAVE A FINISHED SILL HEIGHT NOT MORE THAN 44" ABOVE THE FLOOR
- 4. TANKLESS WATER HEATERS SHALL BE NATIONALLY LISTED AND BE INSTALLED IN ACCORDANCE WITH THE INSTALLATION INSTRUCTIONS THAT WERE APPROVED AS PART OF THEIR LISTING. V.O.A. THRU ROOF, THE GAS PIPING SERVING THE APPLIANCE MUST BE SIZED IN ACCORDANCE WITH THE WATER HEATERS LISTED
- INSTALLATION INSTRUCTIONS AND THE 2019 CPC. 5. THE MAXIMUM SLOPE OF ANY LANDING SHALL NOT EXCEED 1/4 INCH PER FOOT. (R311.3 CRC) 6. A FLOOR OR LANDING IS REQUIRED ON EACH SIDE OF EVERY EXTERIOR DOOR IN ACCORDANCE
- WITH CRC SECTION R311.3. THE LANDING SHALL HAVE A WIDTH NOT LESS THAN THE WIDTH OF THE DOOR AND BE A MINIMUM OF 36" IN LENGTH. THE LANDING AT REQUIRED OUT-SWINGING DOOR SHALL NOT BE MORE THAN 1 1/2" LOWER THAN THE TOP OF THE
- 7. THE LANDING AT IN-SWINGING DOORS AND DOORS OTHER THAN THE REQUIRED EGRESS SHALL NOT BE MORE THAN 7 3/4" BELOW THE TOP OF THE THRESHOLD.

INTERIOR WALL AND CEILING COVERING

INTERIOR WALLS AND CEILINGS SHALL BE COVERED WITH ONE LAYER GYPSUM WALL BOARD, NAILED DIRECTLY TO STUDS AND JOISTS, WITH ALL SEAMS TAPED AND FILLED FLUSH WITH APPROVED JOINT COMPOUND IN ACCORDANCE WITH THE MANUFACTURER'S SPECIFICATIONS. ALL NAILHEADS SHALL BE DIMPLED AND SPACKELED FLUSH WITH COMPOUND.

DRYWALL NAILING SHALL BE PER 2019 CALIFORNIA BUILDING CODE SHALL BE INSPECTED PRIOR TO TAPING AND SPACKELING.

NAIL 5/8" GYP. BOARD WITH 64 COOOLER NAILS, & 1/2" GYP. BOARD WITH 54 COOLER NAILS @ MINIMUM 7" OC EDGES AND FIELD. (2019 CALIFORNIA BUILDING CODE).

ALL EXPOSED GYP. BOARD SHALL HAVE METAL EDGES.

ALL GYP. BOARD AND CORNERBEAD NAILING TO BE INSPECTED AND APPROVED PRIOR TO TAPING.

TUB AND SHOWER WALLS, CEMENT, FIBER-CEMENT, FIBER-MAT REINFORCED CEMENT, GLASS MAT GYPSUM OR FIBER-REINFORCED GYPSUM BACKERS SHALL BE USED AS A BASE FOR WALL TILE IN TUB AND SHOWER AREAS AND WALL AND CEILING PANELS IN SHOWER AREAS IN ACCORDANCE WITH CRC SECTION R702.4.2 CRC.

FLOOR PLAN KEY NOTES

- 101. UN-FINISHED GARAGE, WALLS AND CEILING OPEN TO THE FRAMING.
- 102. NOT USED 103. 2"x 6" STUDS AT 16" O.C. EXTERIOR
- 104. 2"x 8" STUDS AT 16" O.C. EXTERIOR.
- 105. NOT USED
- 106. NOT USED 107. NOT USED
- 108. CONCRETE STOOP, MINIMUM 36" x WIDTH OF DOOR
- 109. CONCRETE DRIVEWAY TO MATCH EXISTING 110. NOT USED
- 111. NOT USED
- 112. NOT USED 113. NOT USED 115. NOT USED
- 116. NOT USED
- 117. NOT USED 118. HOSE BIBB, 3/4"
- 119. NOT USED
- 120. NOT USED 121. NOT USED
- 122. SUB PANEL, SEE SHEET E1 123. NOT USED
- 124. NOT USED

Framing notes: 1. FIRE BLOCKING MUST BE PROVIDED IN ACCORDANCE WITH CRC SECTION R302.11 AT THE FOLLOWING LOCATIONS:

- A. IN CONCEALED SPACES OF STUD WALLS AND PARTITIONS, INCLUDING FURRED
- SPACES, AT THE CEILING AND FLOOR LEVELS. B. IN CONCEALED SPACES OF STUD WALLS AND PARTITIONS, INCLUDING FURRED
- SPACES, AT 10-FOOT INTERVALS ALONG THE LENGTH OF THE WALL. C. AT ALL INTERCONNECTIONS BETWEEN CONCEALED VERTICAL AND HORIZONTAL SPACES SUCH AS OCCUR AT SOFFITS, DROP CEILINGS AND COVE CEILINGS.
- D. IN OPENINGS AROUND VENTS, PIPES, DUCTS, CHIMNEYS, FIREPLACES AND SIMILAR OPENINGS WHICH AFFORD A PASSAGE FOR FIRE AT CEILING AND FLOOR LEVELS, WITH MATERIALS TESTED FOR THE FORM AND MANNER THEY ARE INTENDED.
- 2. WHERE TOP OR SOLE PLATE ARE CUT FOR PIPES, A METAL TIE MINIMUM 0.058 INCHES THICK AND 11/2 " WIDE SHALL BE FASTENED ACROSS THE OPENING WITH
- (6) 16D NAILS MINIMUM EACH SIDE. 3. FIELD CUTTING ENDS, NOTCHES AND DRILLED HOLES IN PRESERVATIVE-TREATED WOOD SHALL BE TREATED IN THE FIELD IN ACCORDANCE WITH AWPA M4.
- 4. NEW FRAMING LUMBER SHALL HAVE 19% MAXIMUM MOISTURE AT TIME OF

INSTALLATION AND FABRICATION


WALL LEGEND

NEW WALL, 2"x 6" STUDS AT 16" O.C.

NEW WALL, 2"x 8" STUDS AT 16" O.C.

DRAWINGS ISSUED FOR:

MICHAEL D. CARPENTER

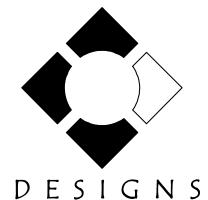


BUILDING DESIGN SERVICES

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PROJECT:

TENBERGE RV GARAGE


12795 ROSS AVE. CHINO, CA. 91710

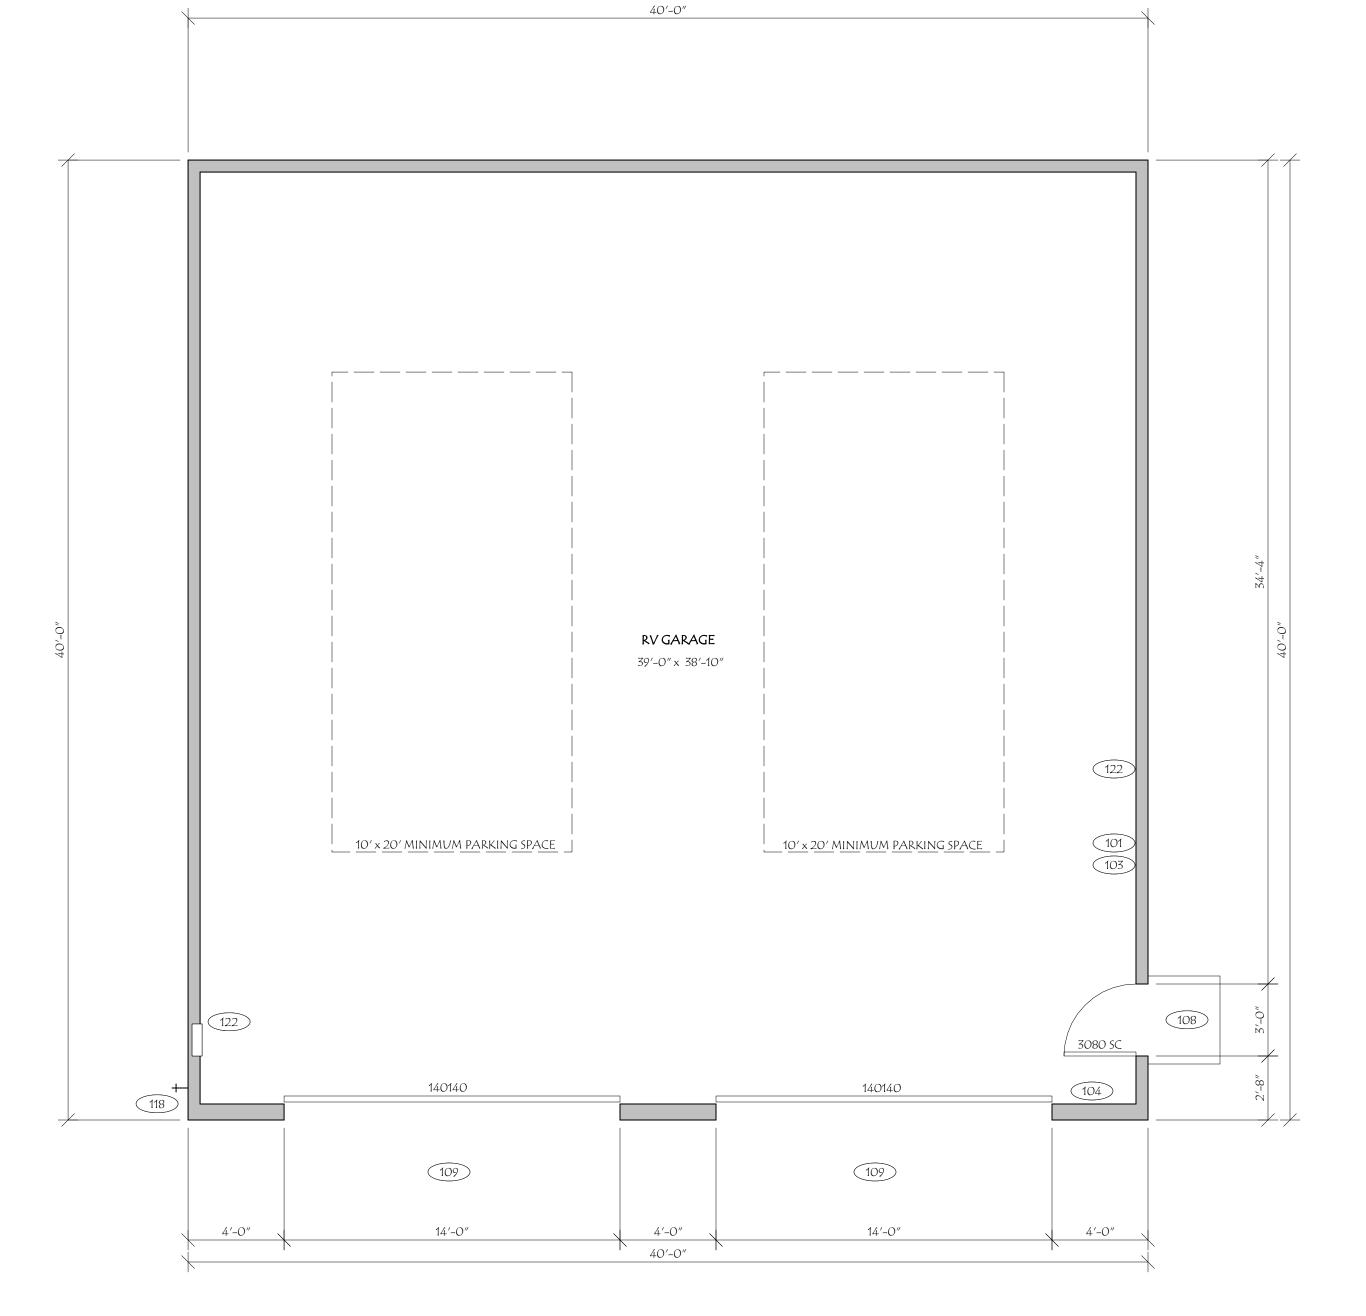SHEET DESCRIPTION:

FLOOR PLAN

SCALE: 1/4'' = 1'-0''

SHEET NUMBER:

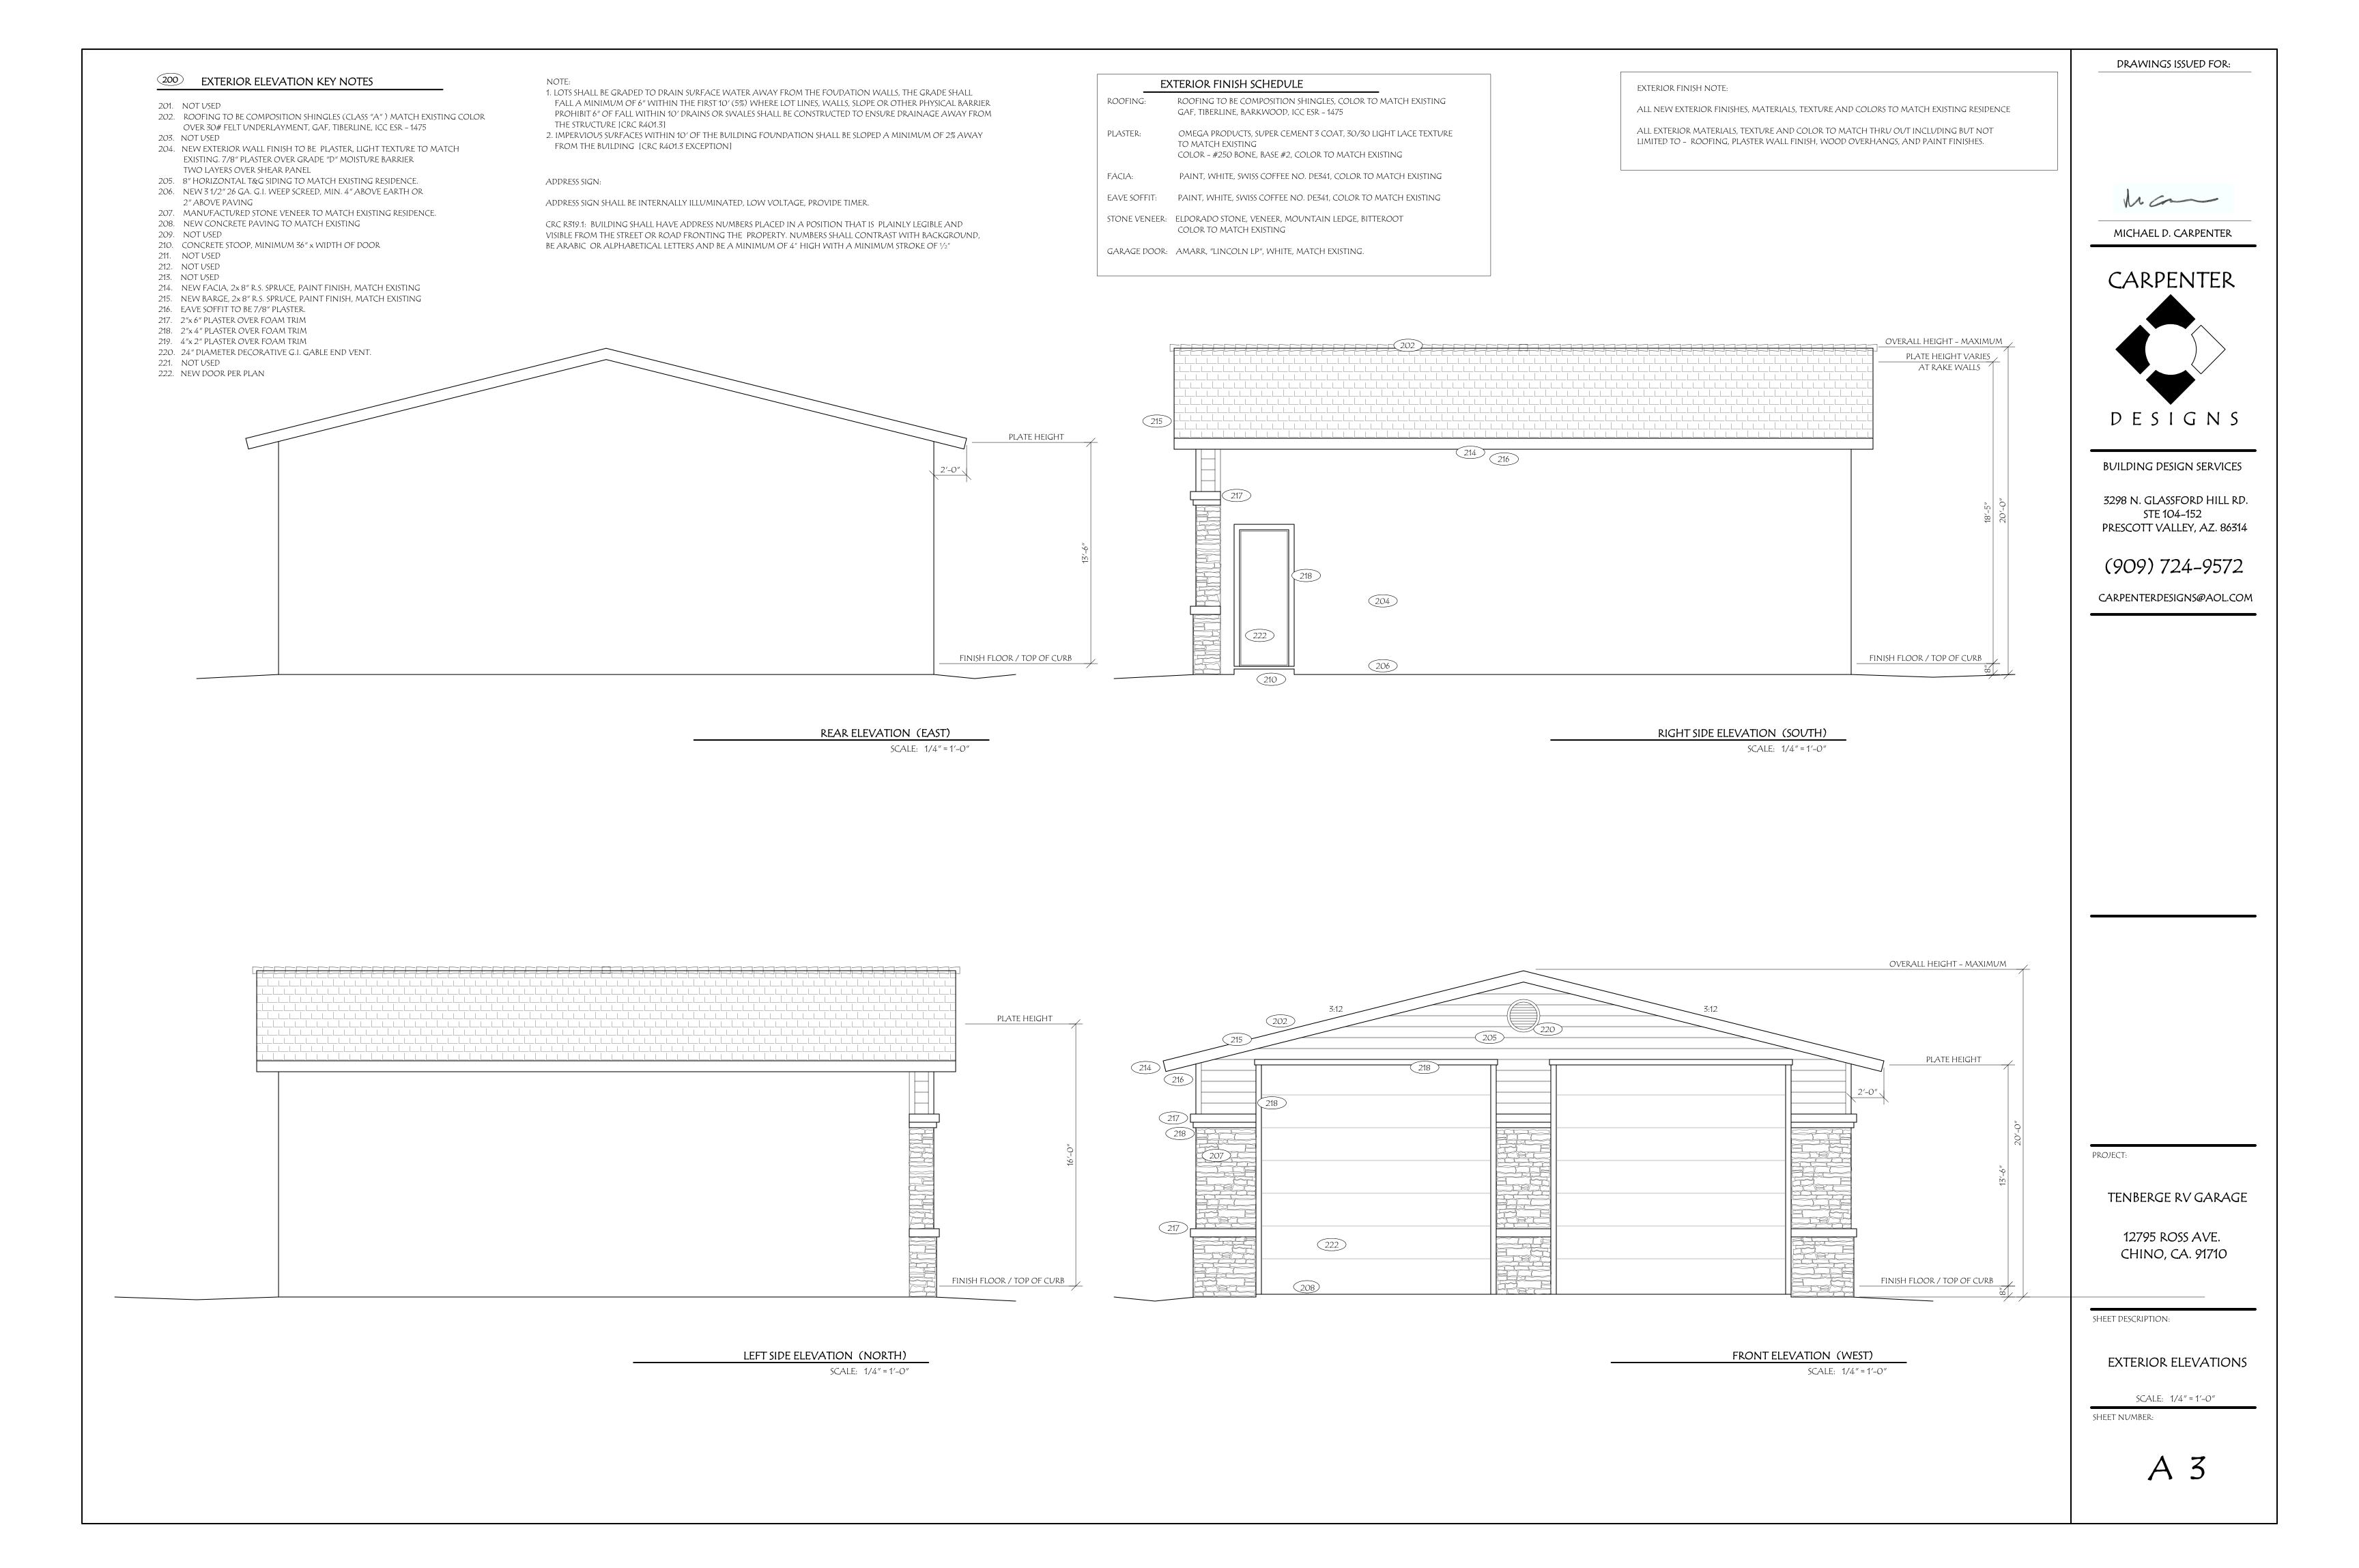



MICHAEL D. CARPENTER

CARPENTER



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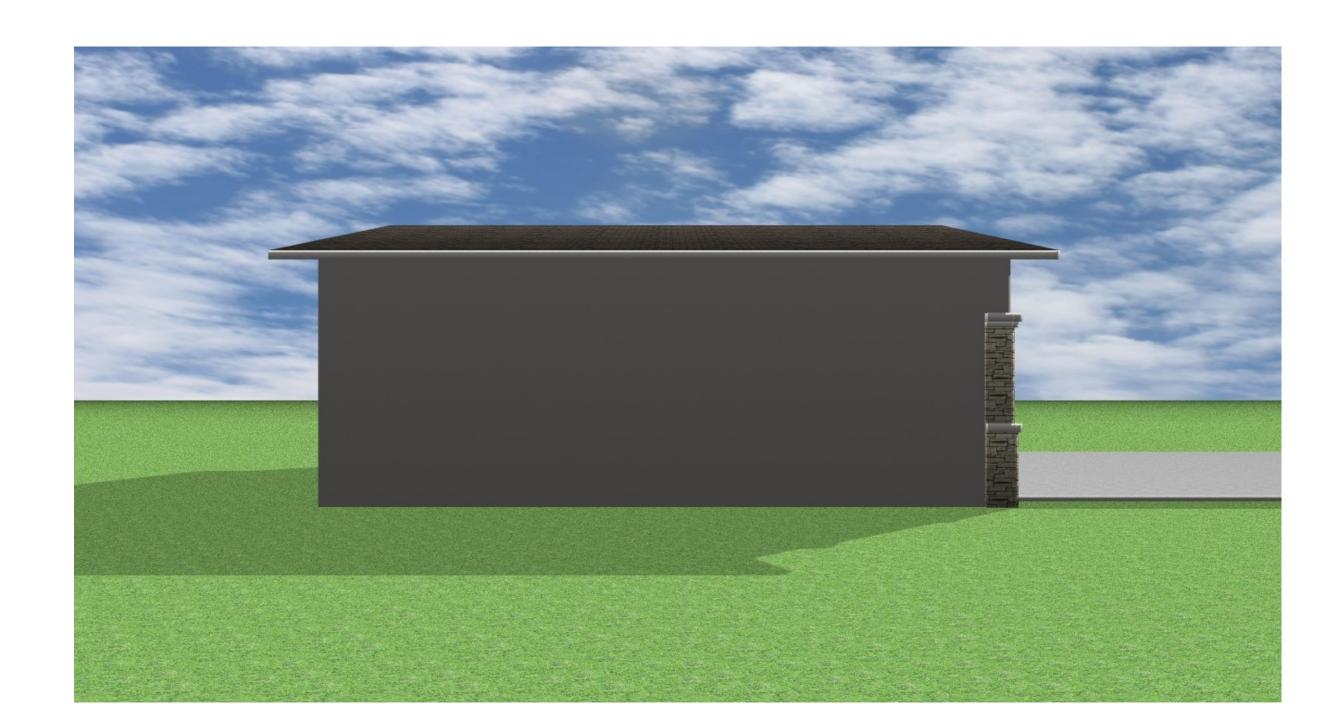
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REAR ELEVATION (EAST)

RIGHT SIDE ELEVATION (SOUTH)



LEFT SIDE ELEVATION (NORTH)



FRONT ELEVATION (WEST)

PROJECT:

TENBERGE RV GARAGE

12795 ROSS AVE. CHINO, CA. 91710

SHEET DESCRIPTION:

EXTERIOR ELEVATIONS COLORED

SCALE: 1/4" = 1'-0"

SHEET NUMBER:

A 4

BARGE

ROOF NOTES :

COMPOSITION SHINGLES (CLASS "A") OVER TWO LAYERS 15# FELT UNDERLAYMENT (MATCH EXISTING COLOR). GAF, TIBERLINE, ICC ESR - 1475

2. FLASH AND COUNTER FLASH AT ROOF TO WALL CONDITIONS.

3. INSTALL ROOFING PER MANUFACTURERS HIGH WIND SPECIFICATIONS

4. PROVIDE DRIP EDGE METAL AT EAVE LINE. 5. RADIANT BARRIER ROOF SHEATHING IS NOT REQUIRED.

6. PROVIDE TWO LAYERS OF WEATHER BARRIER FOR ROOF PITCH LESS THAN 4:12

ROOF PLAN SCALE: 1/4'' = 1'-0'' DRAWINGS ISSUED FOR:

Man

MICHAEL D. CARPENTER

CARPENTER



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PROJECT:

TENBERGE RV GARAGE

12795 ROSS AVE. CHINO, CA. 91710

SHEET DESCRIPTION:


ROOF PLAN


SCALE: 1/4'' = 1'-0''SHEET NUMBER:

300 CROSS SECTION KEY NOTES

- 301. NEW COMPOSITION SHINGLES (CLASS "A") OVER TWO LAYERS 15# FELT UNDERLAYMENT, MATCH EXISTING ROOFING
- INSTALL PER MFG. HIGH WIND SPECIFICATIONS, GAF, TIBERLINE, ICC ESR 1475 302. EXTERIOR WALL FINISH TO BE PLASTER, LIGHT TEXTURE 7/8" PLASTER OVER GRADE "D" MOISTURE BARRIER
- (TWO LAYERS AT SHEAR PANELS)
 303. NOT USED
- 304. NOT USED 305. 31/2" 26 GA. G.I. WEEP SCREED, MIN. 4" ABOVE EARTH OR 2" ABOVE PAVING
- 306. WINDOWS TO BE DUAL GLAZE, LOW "E" 307. EXTERIOR WALL, 2X6" STUDS AT 16" O.C.
- 308. NOT USED
- 309. NOT USED 310. NOT USED
- 312. NOT USED 313. NOT USED
- 314. CONCRETE STOOP/PAVING, MINIMUM 36" x WIDTH OF DOOR 315. NOT USED
- 316. NOT USED
- 317. FACIA TO BE 2X8" RESAWN SPRUCE, SQUARE CUT, PAINT FINISH 318. BARGE TO BE 2X8", RESAWN SPRUCE, PAINT FINISH
- 319. EAVE SOFFIT TO BE 7/8" PLASTER.
- 320. EXPOSED METALS TO BE PAINT FINISHED, MATCH BACK GROUND COLOR.
 321. NOT USED
- 322. 13/4" x 9 1/2" 2.0E MICROLLAM LVL ROOF RAFTERS @ 16" OC 323. 5/8" ROOF SHEATHING
- 324. "W" BEAM PER PLAN
- 325. NOT USED
- 326. NEW 4" THICK MIN., CONCRETE SLAB WITH #4 REBAR AT 16" O.C. EACH WAY OVER 4" CLEAN SAND OVER 10 MIL. VISQUEEN VAPOR BARRIER OVER 2" CLEAN SAND OVER CLEAN COMPACTED FILL. (TYPICAL)
- 327. 5" THICK MIN., CONCRETE SLAB WITH #4 REBAR AT 16" O.C. EACH WAY OVER 4" CLEAN SAND OVER 10 MIL. VISQUEEN VAPOR BARRIER OVER 2" CLEAN SAND OVER CLEAN COMPACTED FILL. (TYPICAL)
- 328. 12" WIDE, 24" DEEP CONTINUOUS CONCRETE FOOTING WITH (2) # 4 REBAR TOP & BOTTOM, TYPICAL
 329. 16" WIDE X 24" DEEP CONTINUOUS CONCRETE FOOTING WITH (2) # 4 RE BAR TOP
- AND BOTTOM
 330. GRADE BEAM, 24" WIDE, 30" THICK, 34" DEEP CONTINUOUS CONCRETE FOOTING,
- 34' LENGTH WITH (6) # 5 BAR T&B W/ # 4 STIRRUPS AT 12" O.C. 331. 8" CONCRETE CURB, FLUSH TO HOUSE FINISH FLOOR, TYPICAL
- 331. 8" CONCRETE CURB, FLUSH TO HOUSE FINISH FLOOR, TYPICA 332. CONCRETE PEDESTAL, FLUSH TO FINISH FLOOR, TYPICAL
- 333. 30" X 30" X 16" PAD FOOTING W/ # 4 REBAR AT 12" O.C. EA. WY.
- 334. INTERIOR FOOTING, 12" WIDE x 18" DEEP CONTINUOUS CONCRETE FOOTING WITH

 (2) # 4 REBAR TOP & BOTTOM, TYPICAL

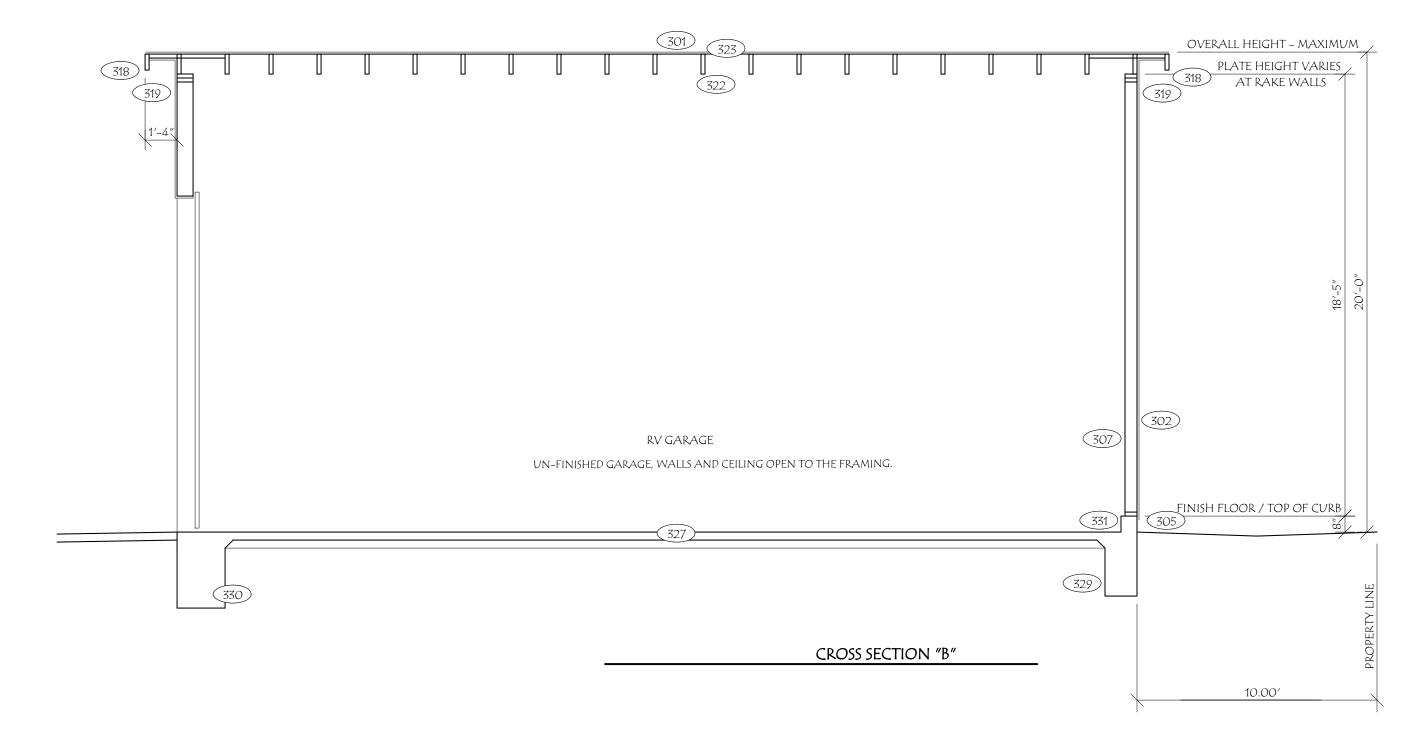

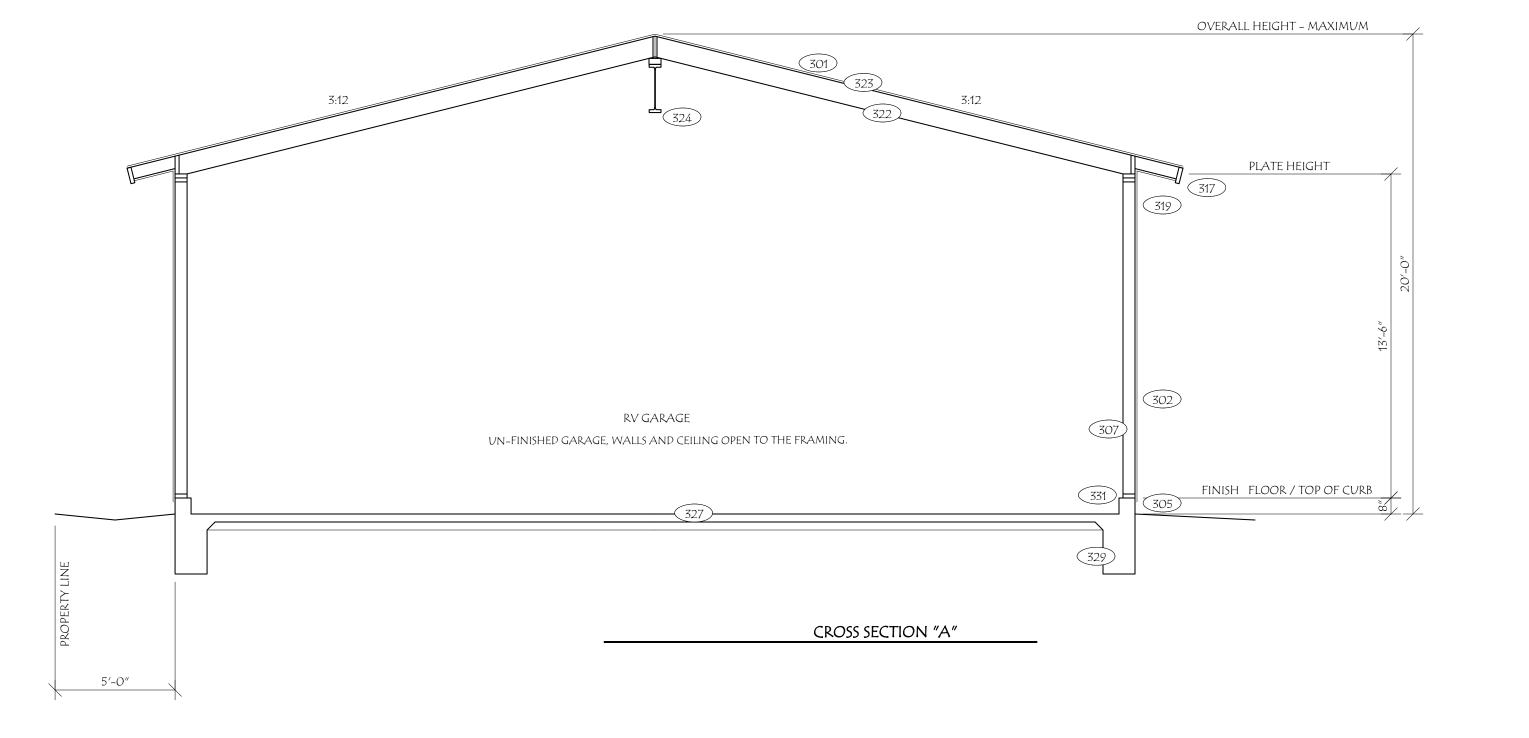

DRAWINGS ISSUED FOR:

han

MICHAEL D. CARPENTER

CARPENTER



BUILDING DESIGN SERVICES

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PROJECT:

TENBERGE RV GARAGE

12795 ROSS AVE. CHINO, CA. 91710

SHEET DESCRIPTION:

CROSS SECTIONS

SCALE: 1/4" = 1'-0"

SHEET NUMBER:

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